
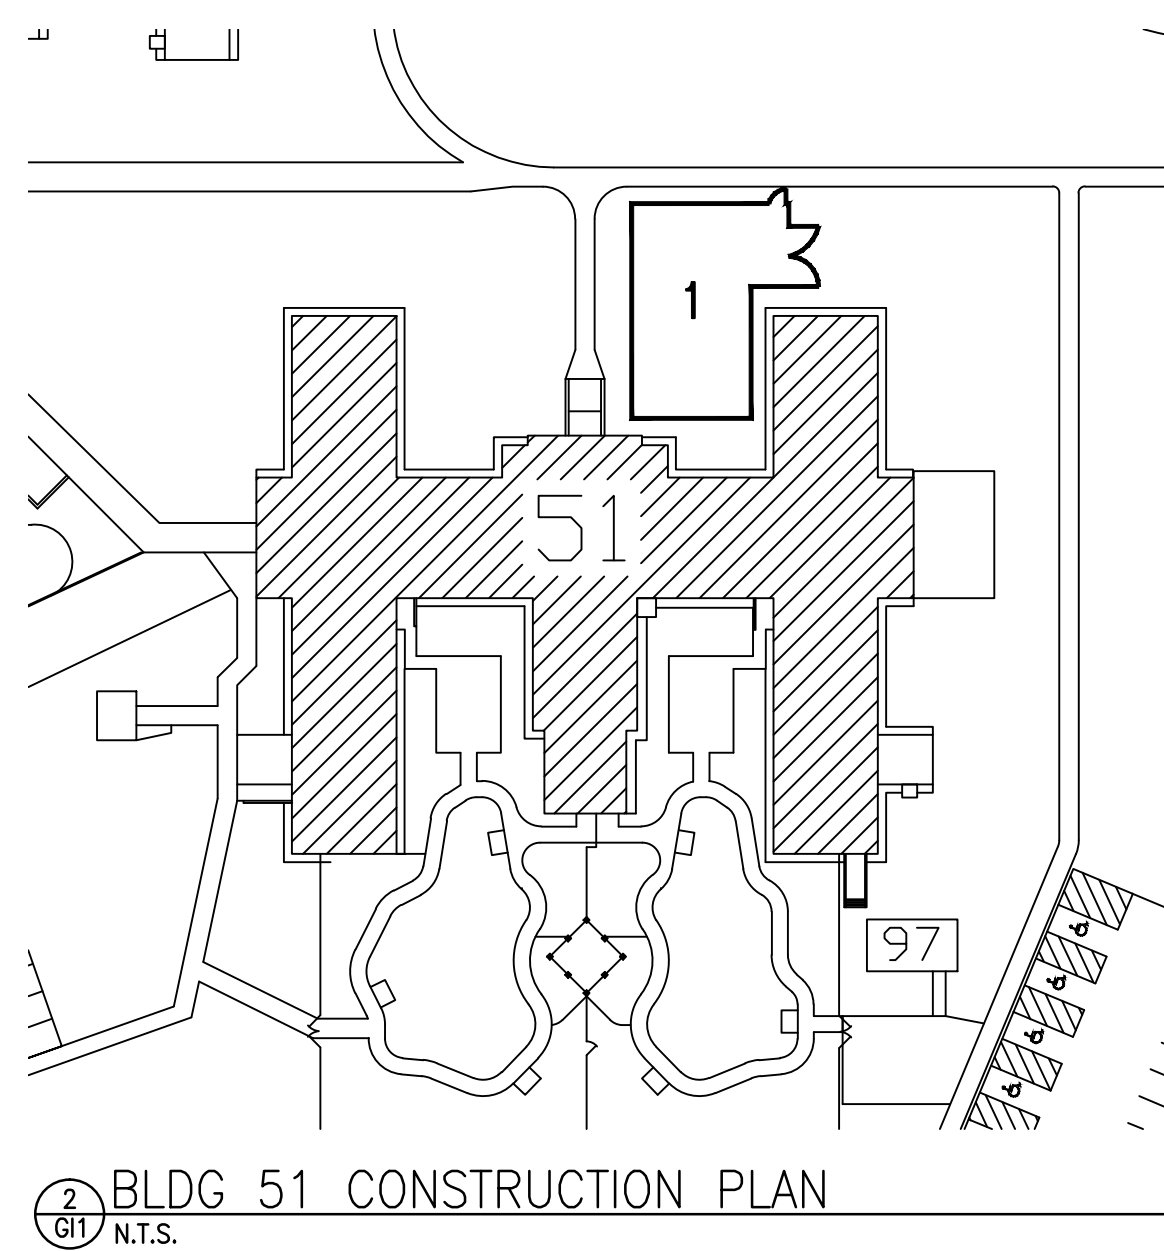


Building 2 & 51 Upgrade Reception Stations

St. Cloud VA Health Care System Main Campus, St. Cloud, Minnesota

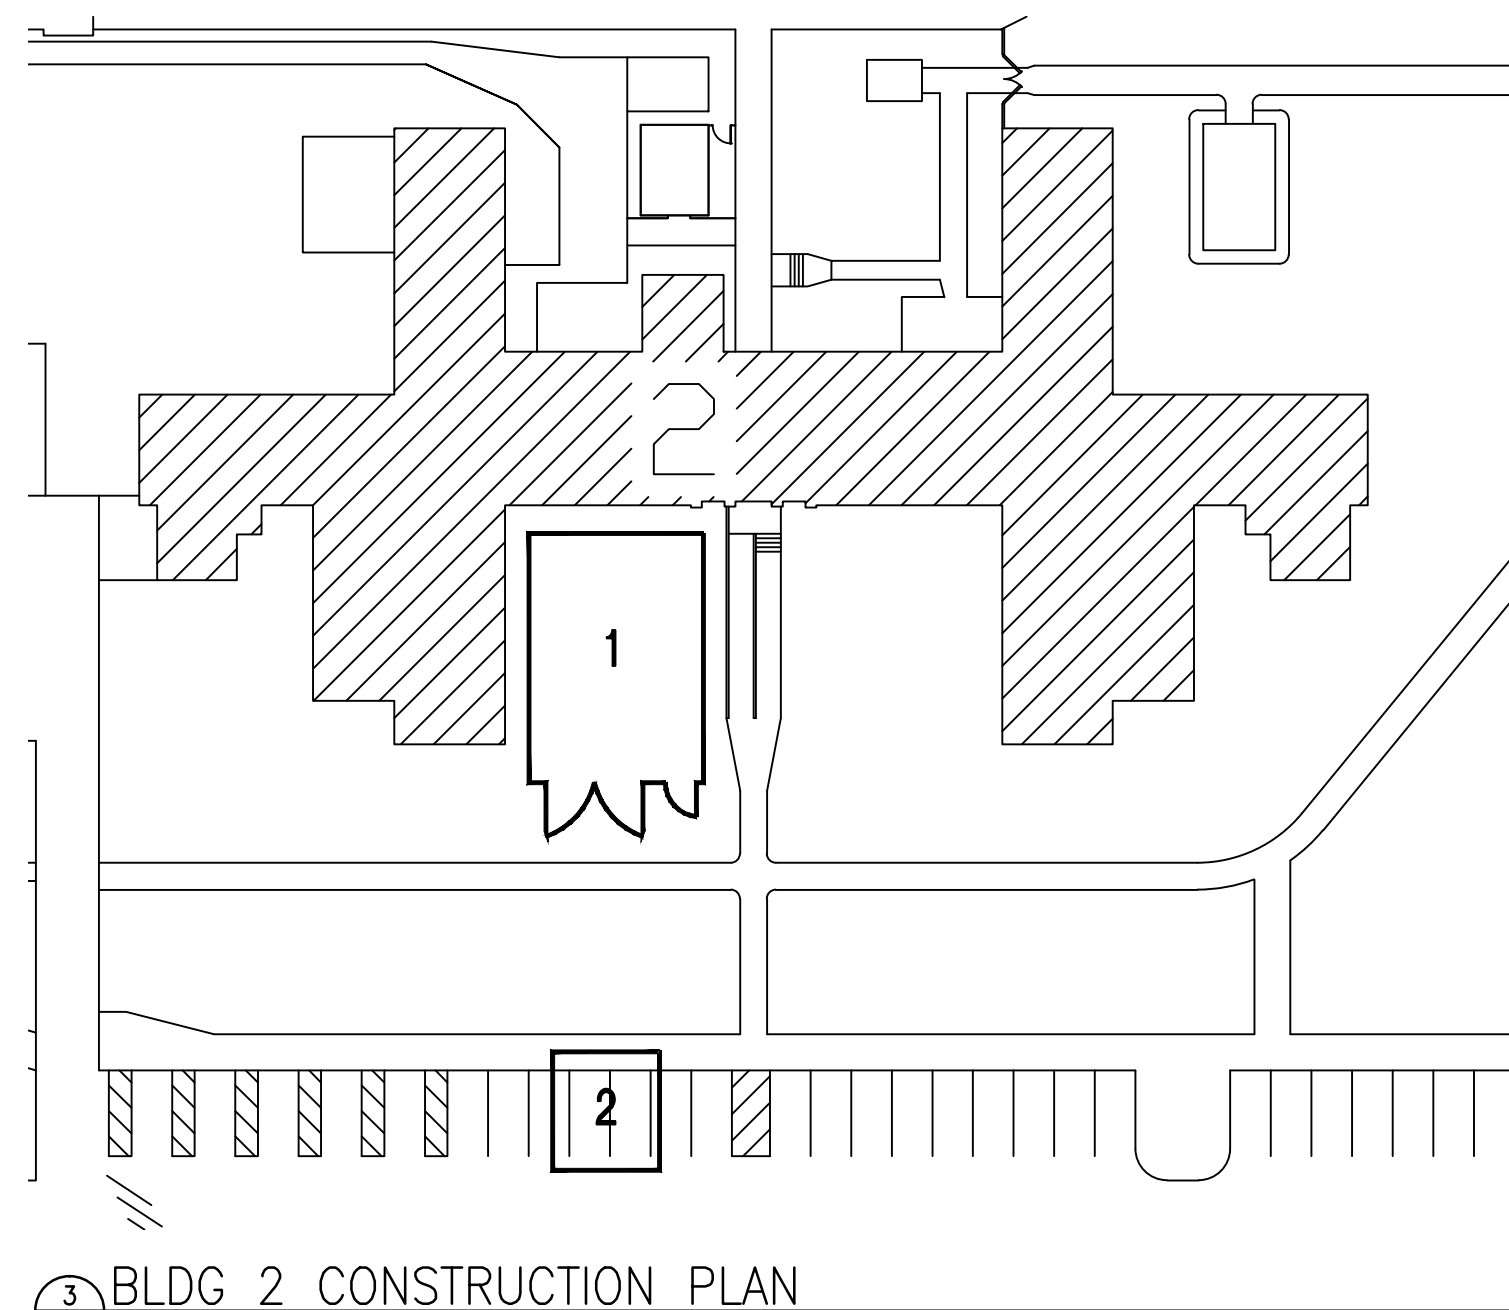

CONTRACTOR PARKING AND STAGING NOTES:


- 1) DESIGNATED PROJECT STAGING AND DUMPSTER AREA
- 2) (2) PARKING STALLS BLOCKED OFF FOR ACCESS TO PROJECT STAGING AREA

GENERAL NOTES:

- CONTRACTOR PARKING: ALLOWED AT DESIGNATED CONTRACTOR PARKING LOTS. UP TO (4) VEHICLES TOTAL. COORDINATE WITH PROJECT COR.

-CONTRACTOR TRAILER: (1) CONSTRUCTION TRAILER ALLOWED IN STAGING AREA OR AT EAST CONTRACTOR PARKING AREA. COORDINATE WITH PROJECT COR. VA NOT RESPONSIBLE FOR LOST OR STOLEN ITEMS.

-8' TALL CHAIN LINK CONSTRUCTION BARRIER REQUIRED. SEE GENERAL CONDITIONS NOTES. UTILITY LOCATES/CHECKS REQUIRED PRIOR TO SETTING OF FENCE.

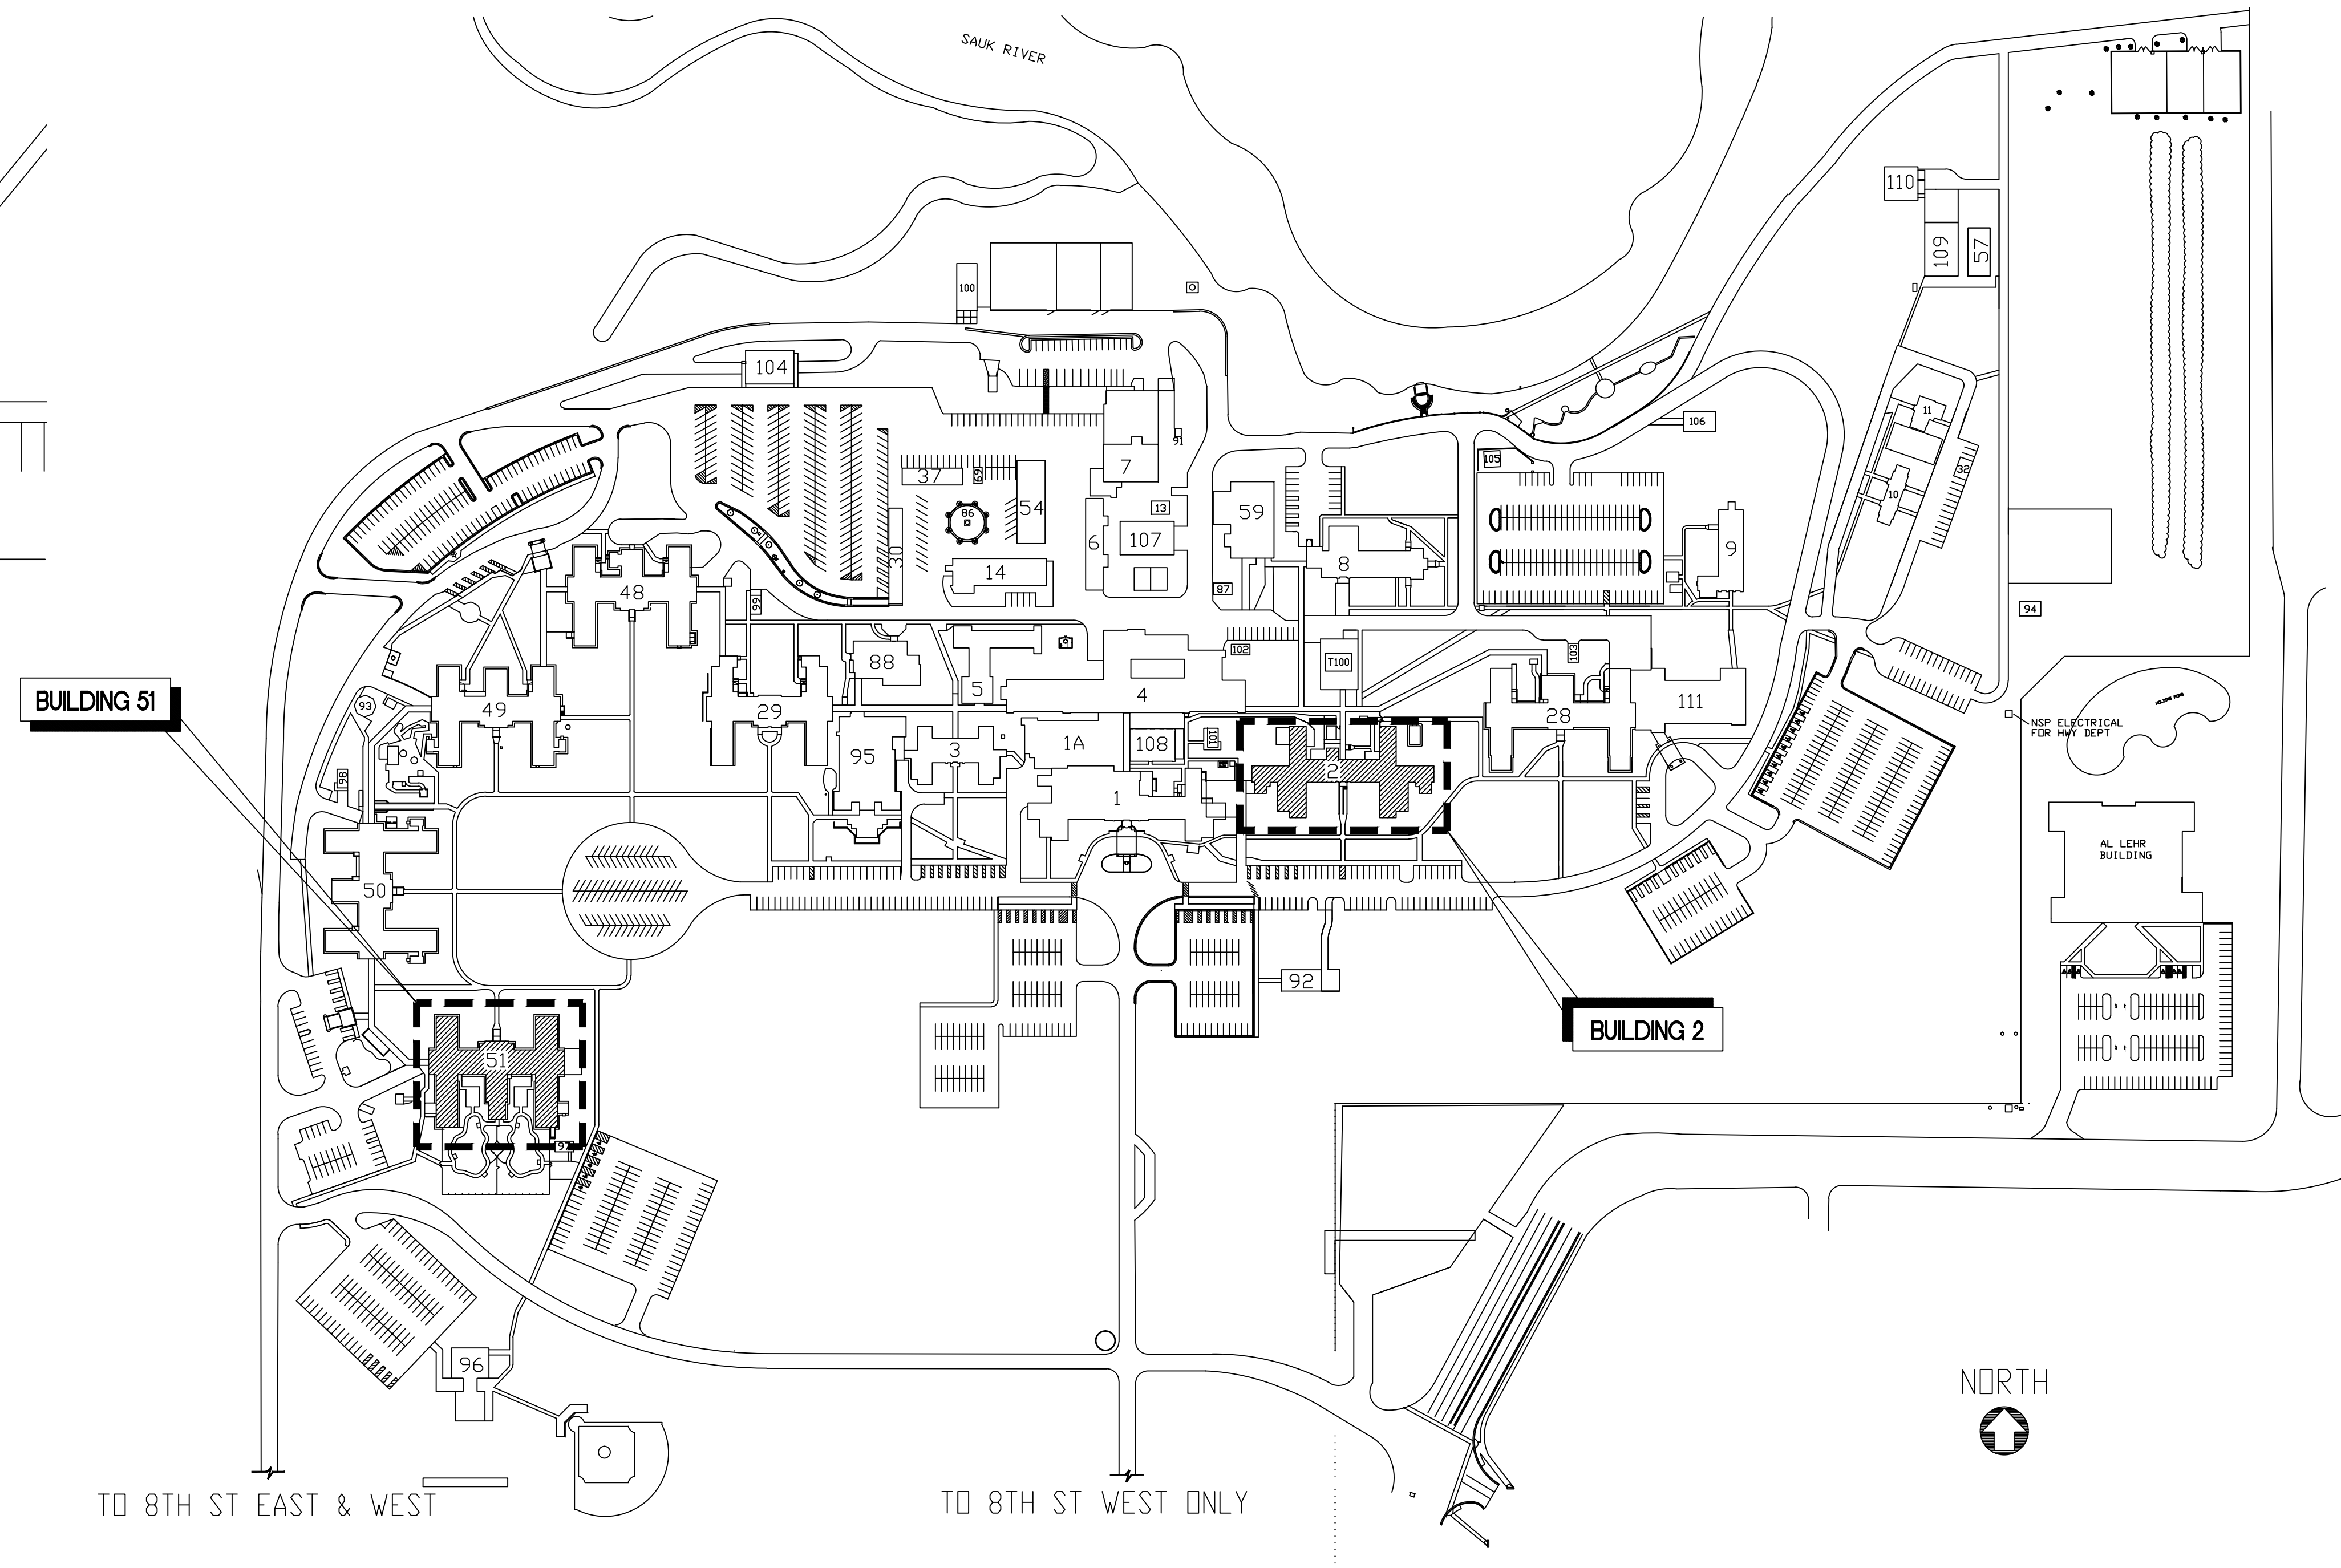

PROJECT PHASE DURATIONS

BUILDING 2

- STATION 121: 20 WORKING DAYS
- OFFICE 101A: 15 WORKING DAYS

BUILDING 51

- STATION 131: 25 WORKING DAYS
- STATION 202: 20 WORKING DAYS
- STATION 116: 1 WORKING DAY
- ROOM 129 FLOORING: 4 WORKING DAYS

GENERAL CONDITIONS

All dimensions on drawings are approximate; Drawings are not to be scaled. It is the responsibility of the contractor to verify all field conditions and physical dimensions that influence the construction area.

It is recommended that contractors visit the proposed construction site prior to submitting their bids and they are encouraged to do so.

Contractor shall adhere strictly to State and Federal Occupational Safety and Health Administration (OSHA) Standards.

Contractor shall park only in the designated parking areas and are not to park on the lawn areas; the only exception is to load or unload supplies or equipment.

Contractor is responsible for the safeguarding of their tools and equipment. All tools and equipment are not to be left unattended and are to be secured at all times when the contractor is not present, or the construction site is not supervised by the contractor.

All VA property is to be safeguarded from damage. Any damaged VA property is to be restored to original condition prior to damage or replaced completely. This includes installation, labor, and procurement expenses.

All demolished material becomes the property and the responsibility of the contractor with the exception of specified items designated either in the plans or verbally requested by the CDR to be retained by the VA. Offsite disposal of the demolished items is the responsibility of the contractor.

Contractor must control demolition and construction dust from facility by erecting a dust barrier and ventilation with hepa filters. If venting to outside, the contractor will insure negative air pressure is maintained in encapsulated work area. When transporting debris, wet down sufficiently to prevent dust spreading.

If scaffolding is used, it must be used in accordance with (OSHA) regulations and is to be enclosed for the first eight feet above ground at end of each working day, until dismantled. Ladders must be removed and locked up at the end of each working day to prevent unauthorized persons from having access.

Clean all debris from construction site to the satisfaction of the CDR.

Contractor is responsible for erecting a barrier around work site to prevent patients, staff and visitors from entering construction site. This fence may be a plastic snow fence at open trench areas. All other areas require a metal chain link fence be erected. Fencing to be 8'-0" high with top and bottom rail.

Provide vehicle/equipment swinging gate (lockable).

Provide swinging man door gate with emergency egress capabilities. Coordinate construction materials and location of fence with CDR.

Contractor is responsible for repairing and replacing any damaged lawn. The restoration will be performed by a landscape contractor that regularly does sodding as part of their business. All damaged lawn will be overcut by 6' or more to accommodate full width rolls of sod. Top soil to be filled and graded to a smooth matching grade of undamaged lawn. Sod to be thoroughly saturated with water upon placement. The contractor is responsible for watering new sod until project acceptance by the CDR.

Access to all buildings and parking areas must be maintained throughout the project.

Contractors are to coordinate all work with the Contracting Officers Representative. (C.O.R.)

SHEET INDEX

GENERAL:

G11 COVER SHEET

ARCHITECTURAL:

AS1 BUILDING 2 - FIRST FLOOR DEMO AND REVISED PLAN
AS2 BUILDING 51 - FIRST FLOOR DEMO AND REVISED PLAN
AS3 BUILDING 51 - SECOND FLOOR DEMO AND REVISED PLAN
AS4 INTERIOR ELEVATIONS
AS5 DETAILS, SCHEDULES
AS6 BUILDING 2 - FIRST FLOOR DEMO AND REFLECTED CEILING PLAN
AS7 BUILDING 51 - FIRST FLOOR DEMO AND REFLECTED CEILING PLAN
AS8 BUILDING 51 - SECOND FLOOR DEMO AND REFLECTED CEILING PLAN

MECHANICAL:

M001 MECHANICAL ABBREVIATIONS, SYMBOLS, + DRAWING INDEX
MH101-2 BUILDING 2 - FIRST FLOOR HVAC DEMO AND REVISED PLAN
MH102-51 BUILDING 51 FIRST FLOOR HVAC DEMO AND REVISED PLAN DETAILS AND SCHEDULES

PLUMBING:

PL101-51 BUILDING 51 - FIRST FLOOR PLUMBING DEMO AND REVISED PLAN


ELECTRICAL:

E11 DRAWING INDEX, LIGHT FIXTURE SCHEDULE AND SYMBOLS
E21 BUILDING 2 FIRST FLOOR OVERALL ELECTRICAL PLAN
E22 BUILDING 51 FIRST FLOOR OVERALL ELECTRICAL PLAN
E23 BUILDING 51 SECOND FLOOR OVERALL ELECTRICAL PLAN
E31 DEMOLITION PLANS
E41 BUILDING 2 FIRST FLOOR ELECTRICAL PLAN - NURSE STATION 121
E42 BUILDING 51 FIRST AND SECOND FLOOR ELECTRICAL PLANS - NURSES STATIONS 116, 131 AND 202
E51 LIGHT FIXTURE AND PANELBOARD SCHEDULES

100% CONSTRUCTION DOCUMENTS

No		REVISION	DATE

JLG architects		Alexandria 525 Broadway Street Alexandria, MN 56308 phone 320.759.9030 facsimile 320.759.9062 www.jlgarchitects.com copyright © 2012	STAMP: I SEAL I HEREBY CERTIFY THAT THIS PLAN WAS PREPARED BY AN ARCHITECT REGISTERED IN THE STATE OF MINNESOTA AND THAT I AM A FULLY LICENSED ARCHITECT UNDER THE LAWS OF THE STATE OF MINNESOTA DANIEL J. MILLER, AIA DATE: 09-19-2013 REG. NO. 191-422416	APPROVED: SERVICE LINE DIRECTOR DATE: _____ APPROVED: SENS COORDINATOR DATE: _____ APPROVED: PROJECTS SECTION MANAGER DATE: _____ APPROVED: DIRECTOR FMS DATE: _____ APPROVED: INFECTION CONTROL NURSE DATE: _____ APPROVED: PATIENT SAFETY DATE: _____ APPROVED: CHIEF OF POLICE DATE: _____ APPROVED: SAFETY MANAGER DATE: _____	DRAWING TITLE PROJECT COVER SHEET APPROVED: ASSOCIATE HEALTH CARE SYSTEM DIRECTOR DATE: _____ APPROVED: CHIEF OF STAFF DATE: _____ APPROVED: HEALTH CARE SYSTEM DIRECTOR DATE: _____	PROJECT TITLE UPGRADE RECEPTION STATIONS BLDG 2 & 51 PROJECT NO. 656-13-226 BUILDING No. 2 & 51 ORDERED BY RWM DRAWN NJC DATE FILED G11_COVER.DWG LOCATION VA MEDICAL CENTER ST. CLOUD, MN 56303 DRAWING NO. G11 DATE: 1 OF 21	DATE 5/15/2013 PROJECT SCALE AS NOTED DRAWN BY 656-13-226	St. Cloud VA Health Care System Brainerd Montevideo Alexandria
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
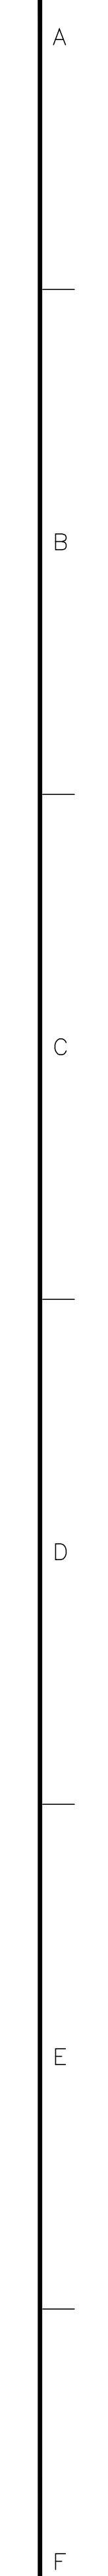
(P1) PHASE 1 CONSTRUCTION BARRIER (P3) CONSTRUCTION BARRIER SERVED BY WALL OF NEW CONSTRUCTION

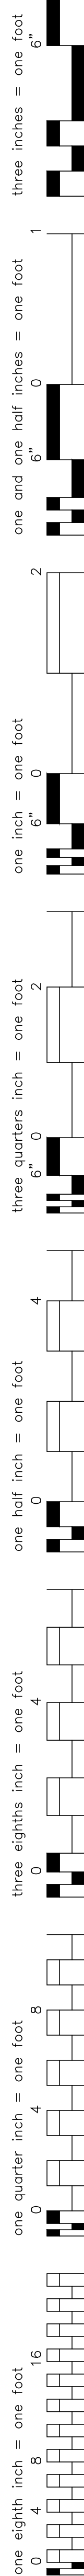(P2) PHASE 2 CONSTRUCTION BARRIER (P4) CONSTRUCTION BARRIER - COORDINATE PHASING WITH COR

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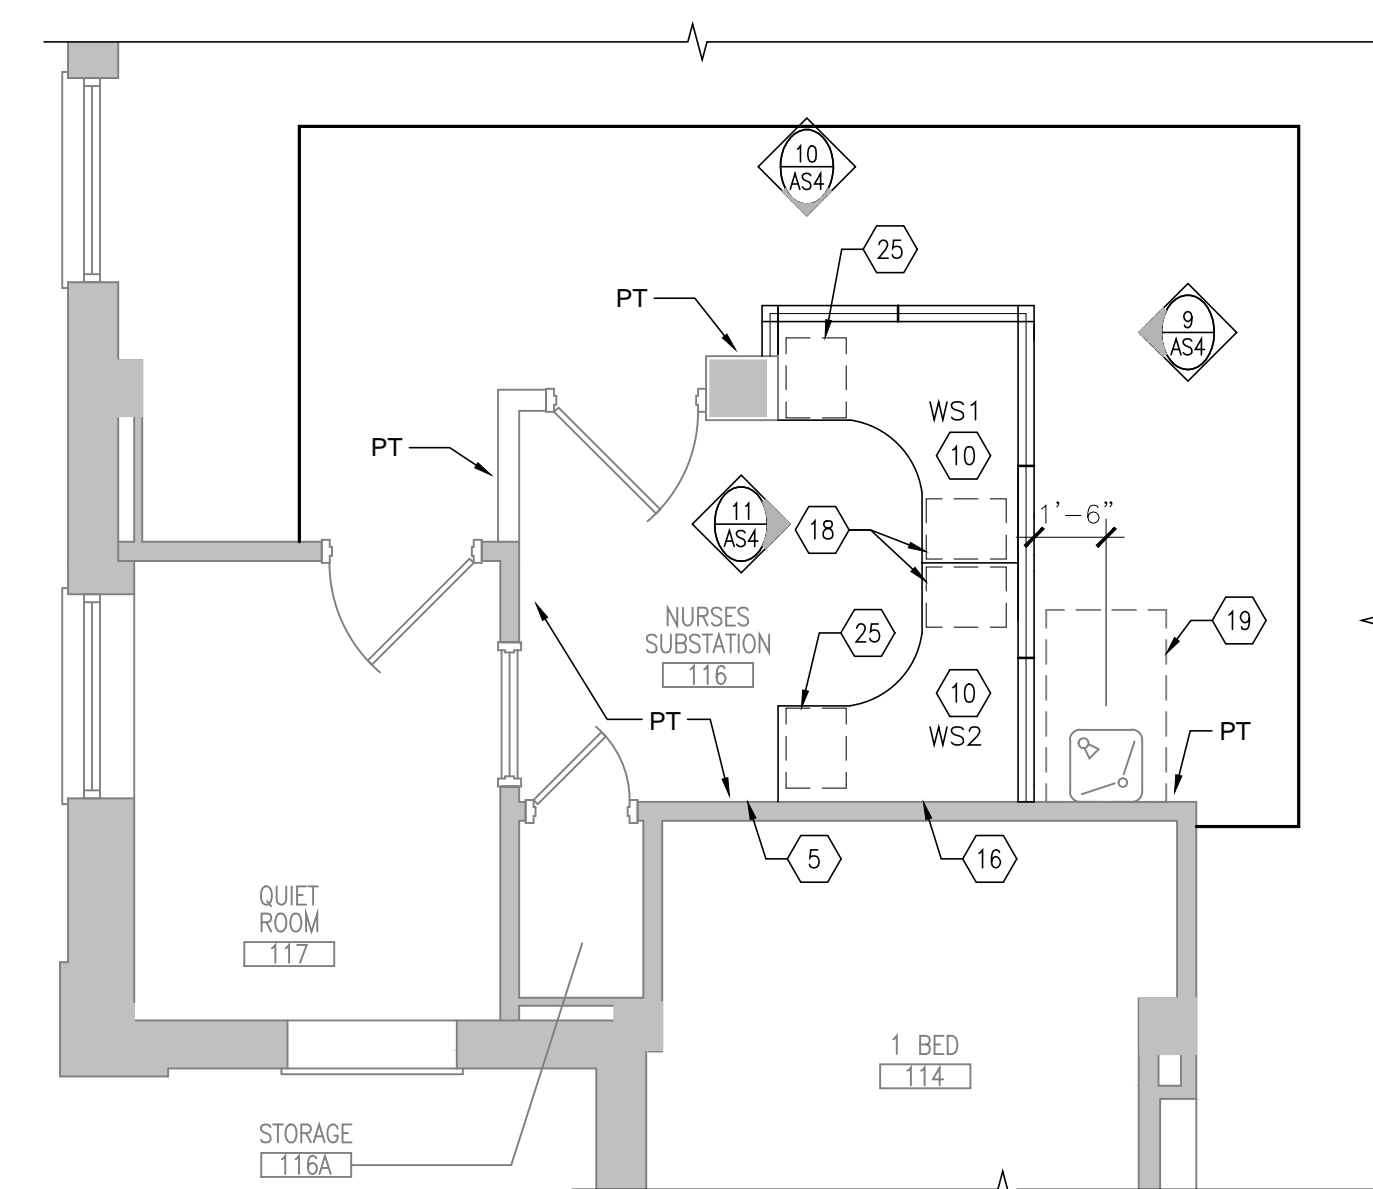
1.	REMOVING MACHINE TO BE REMOVED FROM PROJECT BY VA.	15.	REMOVE EXISTING WALL CONSTRUCTION AS REQUIRED FOR NEW CONSTRUCTION. --SEE PLAN
2.	UNDER COUNTER FILE CABINET TO BE SALVAGED FOR REUSE. --SEE PLAN	16.	HALF HEIGHT DOOR AND WALL TO BE REMOVED.
3.	LATERAL FILE CABINET TO BE SALVAGED FOR REUSE. --SEE PLAN	17.	REMOVE DOOR AND EXISTING CONSTRUCTION AS REQUIRED FOR NEW CONSTRUCTION. --SEE PLAN
4.	UNDER COUNTER REFRIGERATOR TO BE SALVAGED FOR REUSE. --SEE PLAN	18.	HANDRAIL AND BUMPER TO BE SALVAGED FOR REUSE. --SEE PLAN
5.	NOT USED	19.	FISH TANK TO BE REMOVED FROM PROJECT AREA BY VA.
6.	ELECTRICAL PANEL TO REMAIN.	20.	VINYL WALL COVERING (VWC) AT FIRST FLOOR WALLS, COLUMNS, AND SURFACE AREAS TO BE REMOVED. SKIM COAT TOPPINGS AND PREP FOR PRIMER AND PAINT.
7.	BUILDING DIRECTORY (10X43X33) TO BE SALVAGED FOR REUSE. --SEE PLAN	21.	REMOVE EXISTING FLOORING AS REQUIRED FOR NEW CONSTRUCTION.
8.	MODULAR FURNITURE/CASEWORK TO BE REMOVED FROM PROJECT, VERIFY WITH VA ON RELOCATION OR DISPOSAL OF FURNITURE.		
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- B. ALL INTERIOR WALLS SHALL HAVE FULL HEIGHT SOUND INSULATION.
- C. MEASUREMENTS ARE FROM FACES OF EXISTING WALLS, CENTERLINES OF NEW WALLS, AND CENTERLINES OF MARKED OPENINGS/FIXTURES U.N.O.
- D. VERIFY DIMENSIONS AT EXISTING FEATURES TO PROVIDE CLEARANCE FOR NEW CONSTRUCTION.
- E. PATCH FLOORING AND BASE TO MATCH EXISTING AS REQUIRED FOR NEW CONSTRUCTION.

1	REUSE DOOR LOCKS COMPUTER	19	MAINTAIN 48"x30" CLEAR FLOOR SPACE AROUND EXISTING DRINKING FOUNTAIN.
2	REUSE OPEN ACCESS COMPUTER	20	DASHED LINE INDICATES SMOKE PARTITION WALL.
3	REUSE UNDER COUNTER REFRIGERATOR	21	SKIM COAT EXISTING SURFACES AFTER VWC REMOVAL, PROVIDE PRIMER AND PAINT
4	REUSE LATERAL FILES (42X18X63)	22	NEW 42"H MTL DOOR AND FRAME FILLED WITH CONCRETE
5	EXISTING STRESS ALARM BUTTON/CALL STATION	23	NEW CARPET
6	REUSE UNDER COUNTER FILE CABINET	24	PATCH VCT FLOORING TO MATCH EXISTING AT NEW CONSTRUCTION
7	WALL MOUNTED CABINET	25	DOUBLE DRAWER UNDER COUNTER FILE CABINET W/CASTERS (EQUIPMENT <P-1>, SEE SCHEDULE)
8	OMNICELL CABINET (27"x24.5"), VA SUPPLIED	26	INFILL HALF WALL WITH FULL HEIGHT WALL, ADD NEW DOOR AND FRAME
9	S.S. SINK & COUNTERTOP (36" HT.)	27	NEW VCT FLOORING
10	MODULAR FURNITURE SYSTEM - REF. EQUIPMENT SCHEDULE ON SHEET A54	28	FLOORING TRANSITION STRIP
11	REUSE CLOSE CIRCUIT TELEVISION SYSTEM, SEE ELEC.	29	REUSE EXISTING MED REFRIGERATOR
12	REUSE PRINTER	30	NEW RUBBER FLOORING, PROVIDE PATTERN AS INDICATED ON DRAWINGS IN TWO-TONE COLORS. SEE MATERIAL SCHEDULE.
13	REUSE BUILDING DIRECTORY	31	ACCENT WALL (PT. SEE FINISH SCHEDULE)
14	NEW MAILSLLOT CABINET TO MATCH EXISTING CONFIGURATION	32	NEW INTELX MONITORING SYSTEM LOCATION. RUN CABELING IN CONDUIT PLACED IN NORTH SIDE OF COLUMN FURRING.
15	EXISTING MEDCART (35"x25")	33	MAINTAIN EGRESS ROUTE THROUGH SPACE AT ALL TIMES DURING FLOORING INSTALLATION
16	EXISTING CONTROLS	34	BUTT FLOORING MATERIALS SEAMLESS AT TRANSITION
17	REUSE HANDRAIL AND BUMPER		
18	TRIPLE DRAWER UNDER COUNTER FILE CABINET W/CASTERS (EQUIPMENT <P-2>, SEE SCHEDULE)		



three inches = one foot
one and one half inches = one foot
one inch = one foot
one half inch = one foot
three quarters inch = one foot
one half inch = one foot
three eighths inch = one foot
one quarter inch = one foot
one eighth inch = one foot

GENERAL DEMOLITION NOTES:

1. REMOVE INTERIOR WALLS (AS INDICATED ON PLAN WITH DASHED LINES) AS REQUIRED FOR NEW CONSTRUCTION (U.N.O.).
2. PATCH & REPAIR FLOORS, WALLS & CEILING AS REQUIRED WHERE DEMOLITION OCCURS - MATCH EXISTING CONDITIONS.
3. MAINTAIN & PROTECT ACCESS THROUGH MAIN CORRIDOR DURING CONSTRUCTION.
4. DOCUMENT/VERIFY ALL MOUNTING HEIGHTS FOR EQUIPMENT/CABINETS BEFORE REMOVAL. EXISTING EQUIPMENT TO BE RELOCATED WITH MATCHING HEIGHTS U.N.O. PROVIDE BLOCKING FOR MOUNTED OBJECTS WHERE REQUIRED.
5. ALL FURNITURE AND EQUIPMENT TO REMAIN U.N.O.
6. CLEAN ALL EXISTING WALL SURFACES AFTER DEMOLITION AS NECESSARY.

CONSTRUCTION BARRIER NOTES:

- A. CONSTRUCTION BARRIERS TO BE BUILT AS FOLLOWS:
- FULL HEIGHT TO UNDERSIDE OF DECK ABOVE
- 1-HR RATED WITH SOUND INSULATION
- FINISHED ON PATIENT/PUBLIC SIDE
- B. 5'-0" CLEAR MINIMUM DIMENSION TO BE MAINTAINED AT CORRIDORS WITH A CONSTRUCTION BARRIER. CLEAR DIMENSION INCLUDES HANDRAILS, ETC.
- C. SPRINKLER HEADS MUST BE A MIN. 4" OFF A WALL. TEMPORARILY RELOCATE HEADS AS NEEDED TO FOR CONSTRUCTION BARRIER PLACEMENT.
- D. TEMPORARILY RELOCATE FIXTURES AND DEVICES AS NOTED TO COMPLETE CONSTRUCTION BARRIER INSTALLATION.
- E. REPLACE DISTURBED A.C.T. AND GRID TO MATCH EXISTING.
- F. RETURN TEMPORARILY RELOCATED SPRINKLER HEADS, FIXTURES, AND DEVICES TO ORIGINAL LOCATIONS UNLESS INDICATED OTHERWISE.

PHASING KEYNOTES:

- (P1) PHASE 1 CONSTRUCTION BARRIER
(P2) PHASE 2 CONSTRUCTION BARRIER
(P3) CONSTRUCTION BARRIER SERVED BY WALL OF NEW CONSTRUCTION
(P4) CONSTRUCTION BARRIER - COORDINATE PHASING WITH COR

PROJECT DEMOLITION KEYNOTES:

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4. UNDER COUNTER REFRIGERATOR TO BE SALVAGED FOR REUSE. -SEE PLAN
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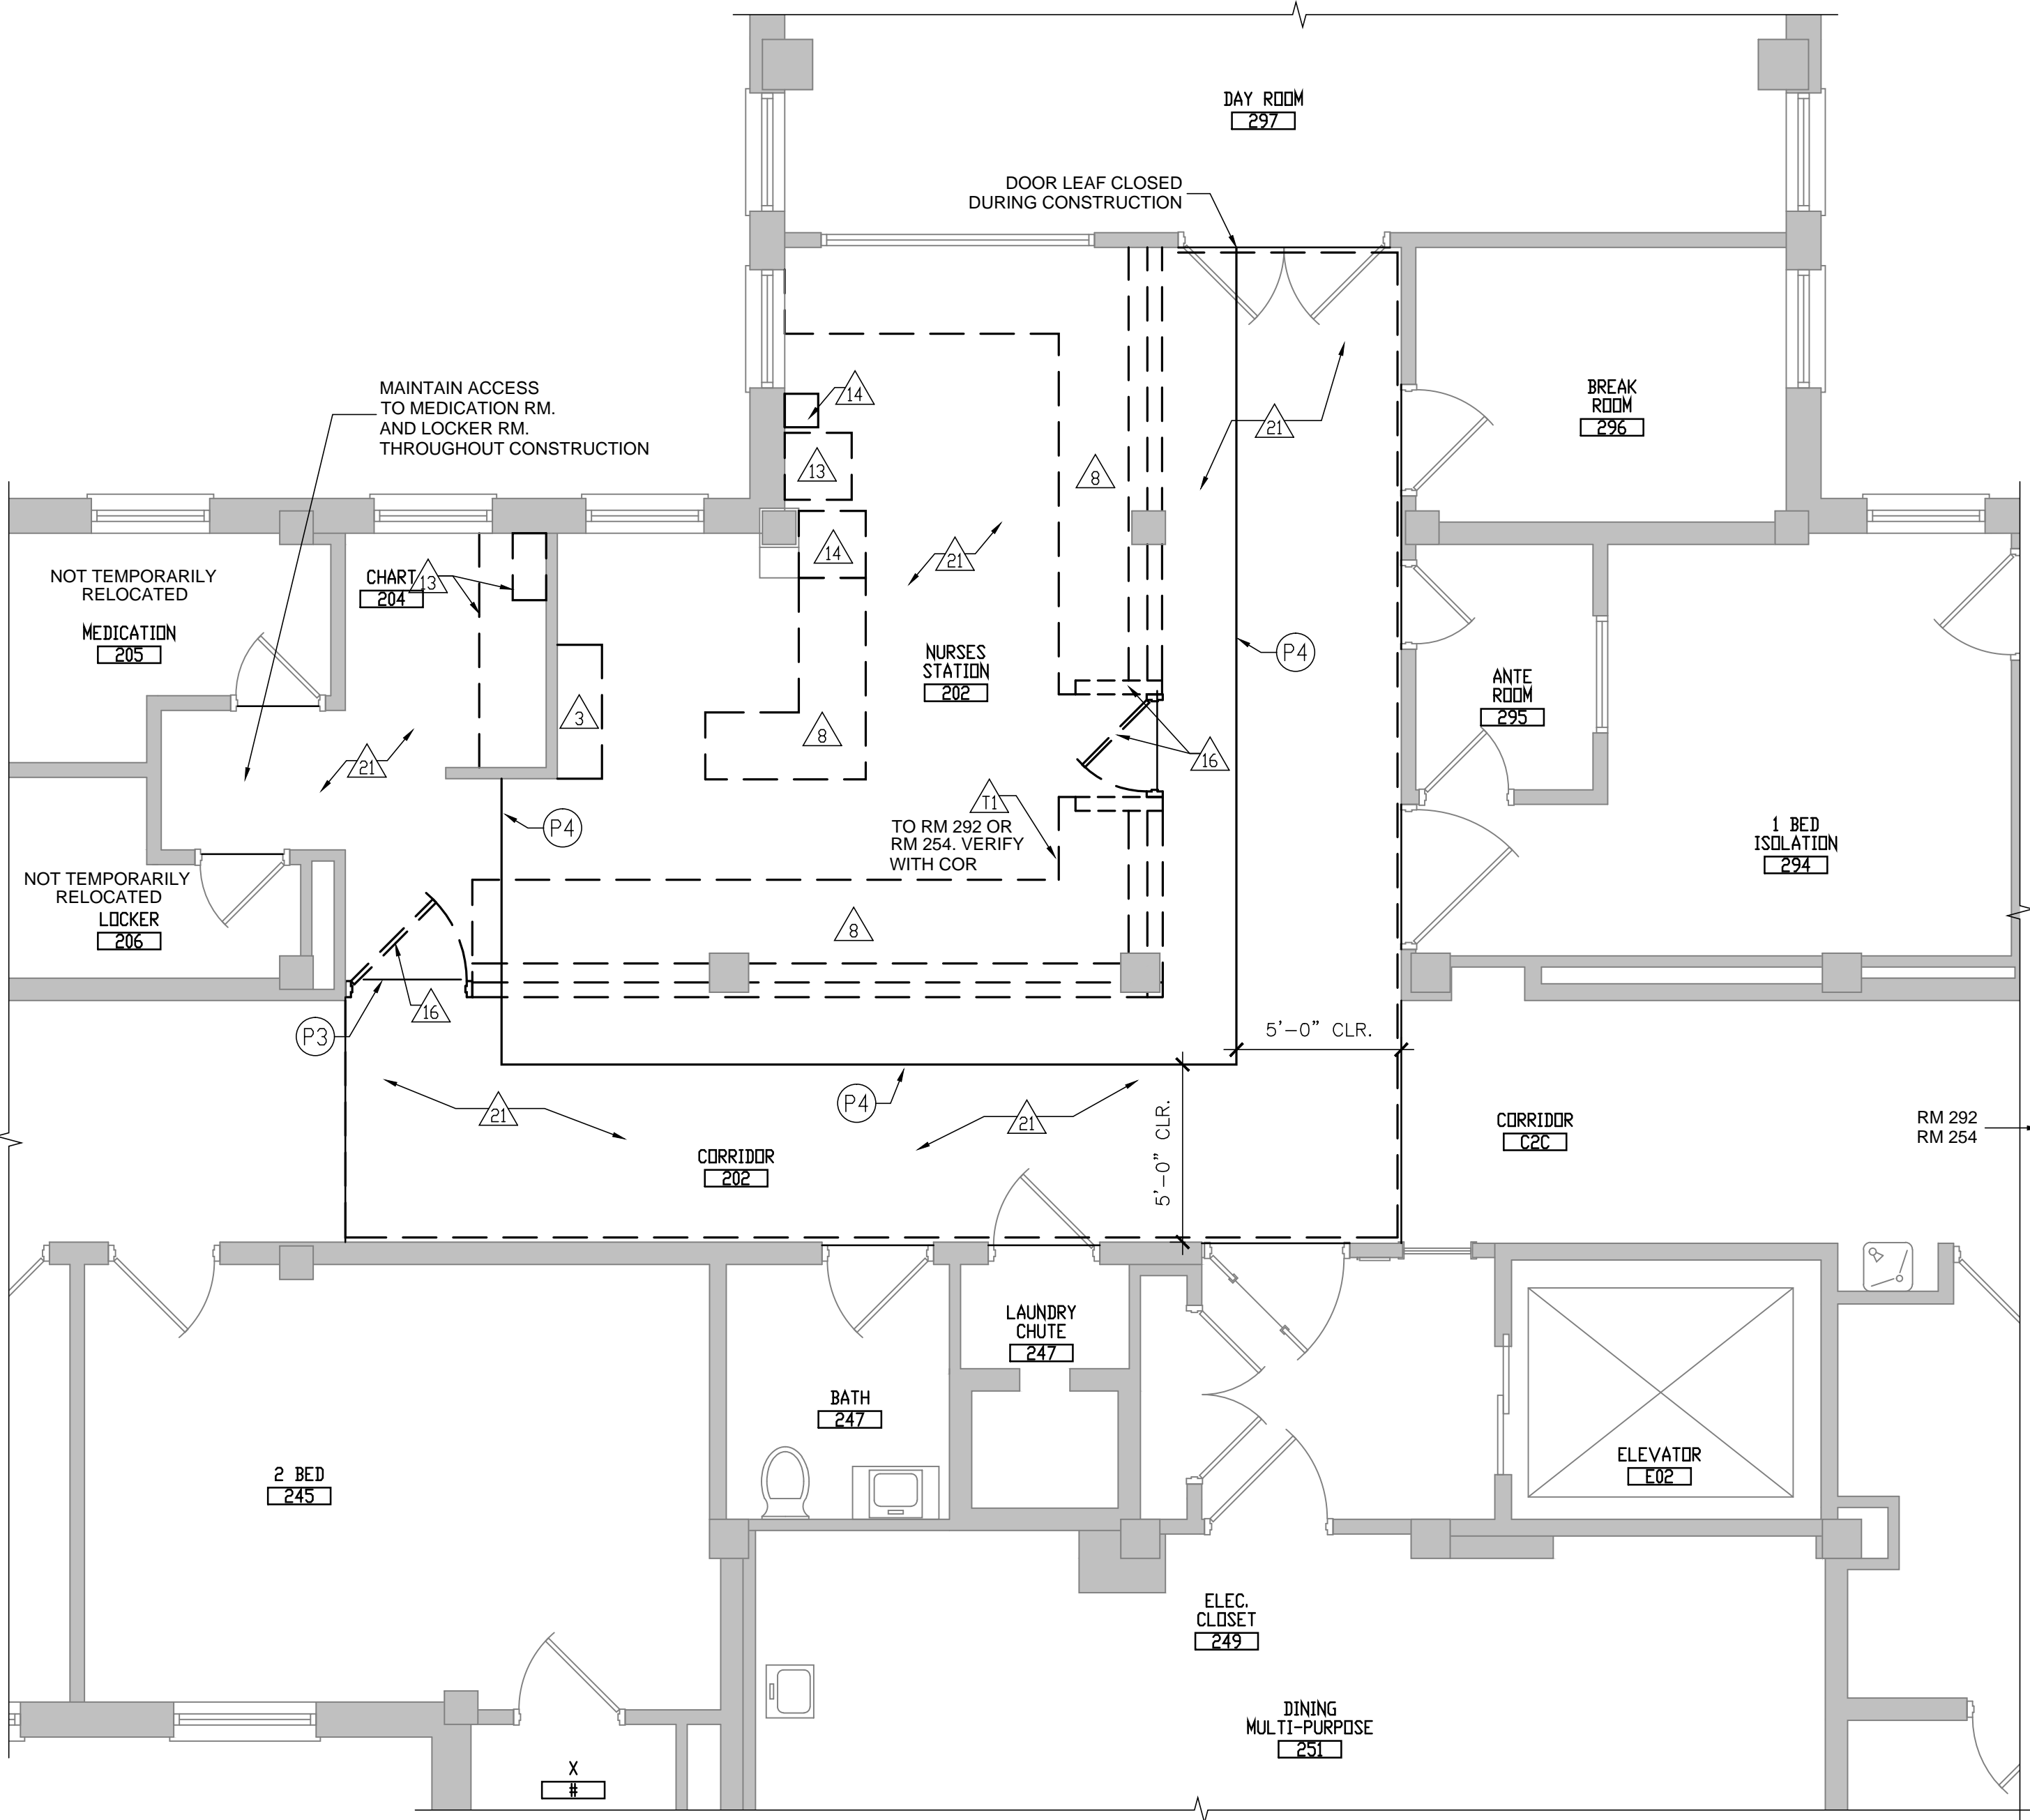
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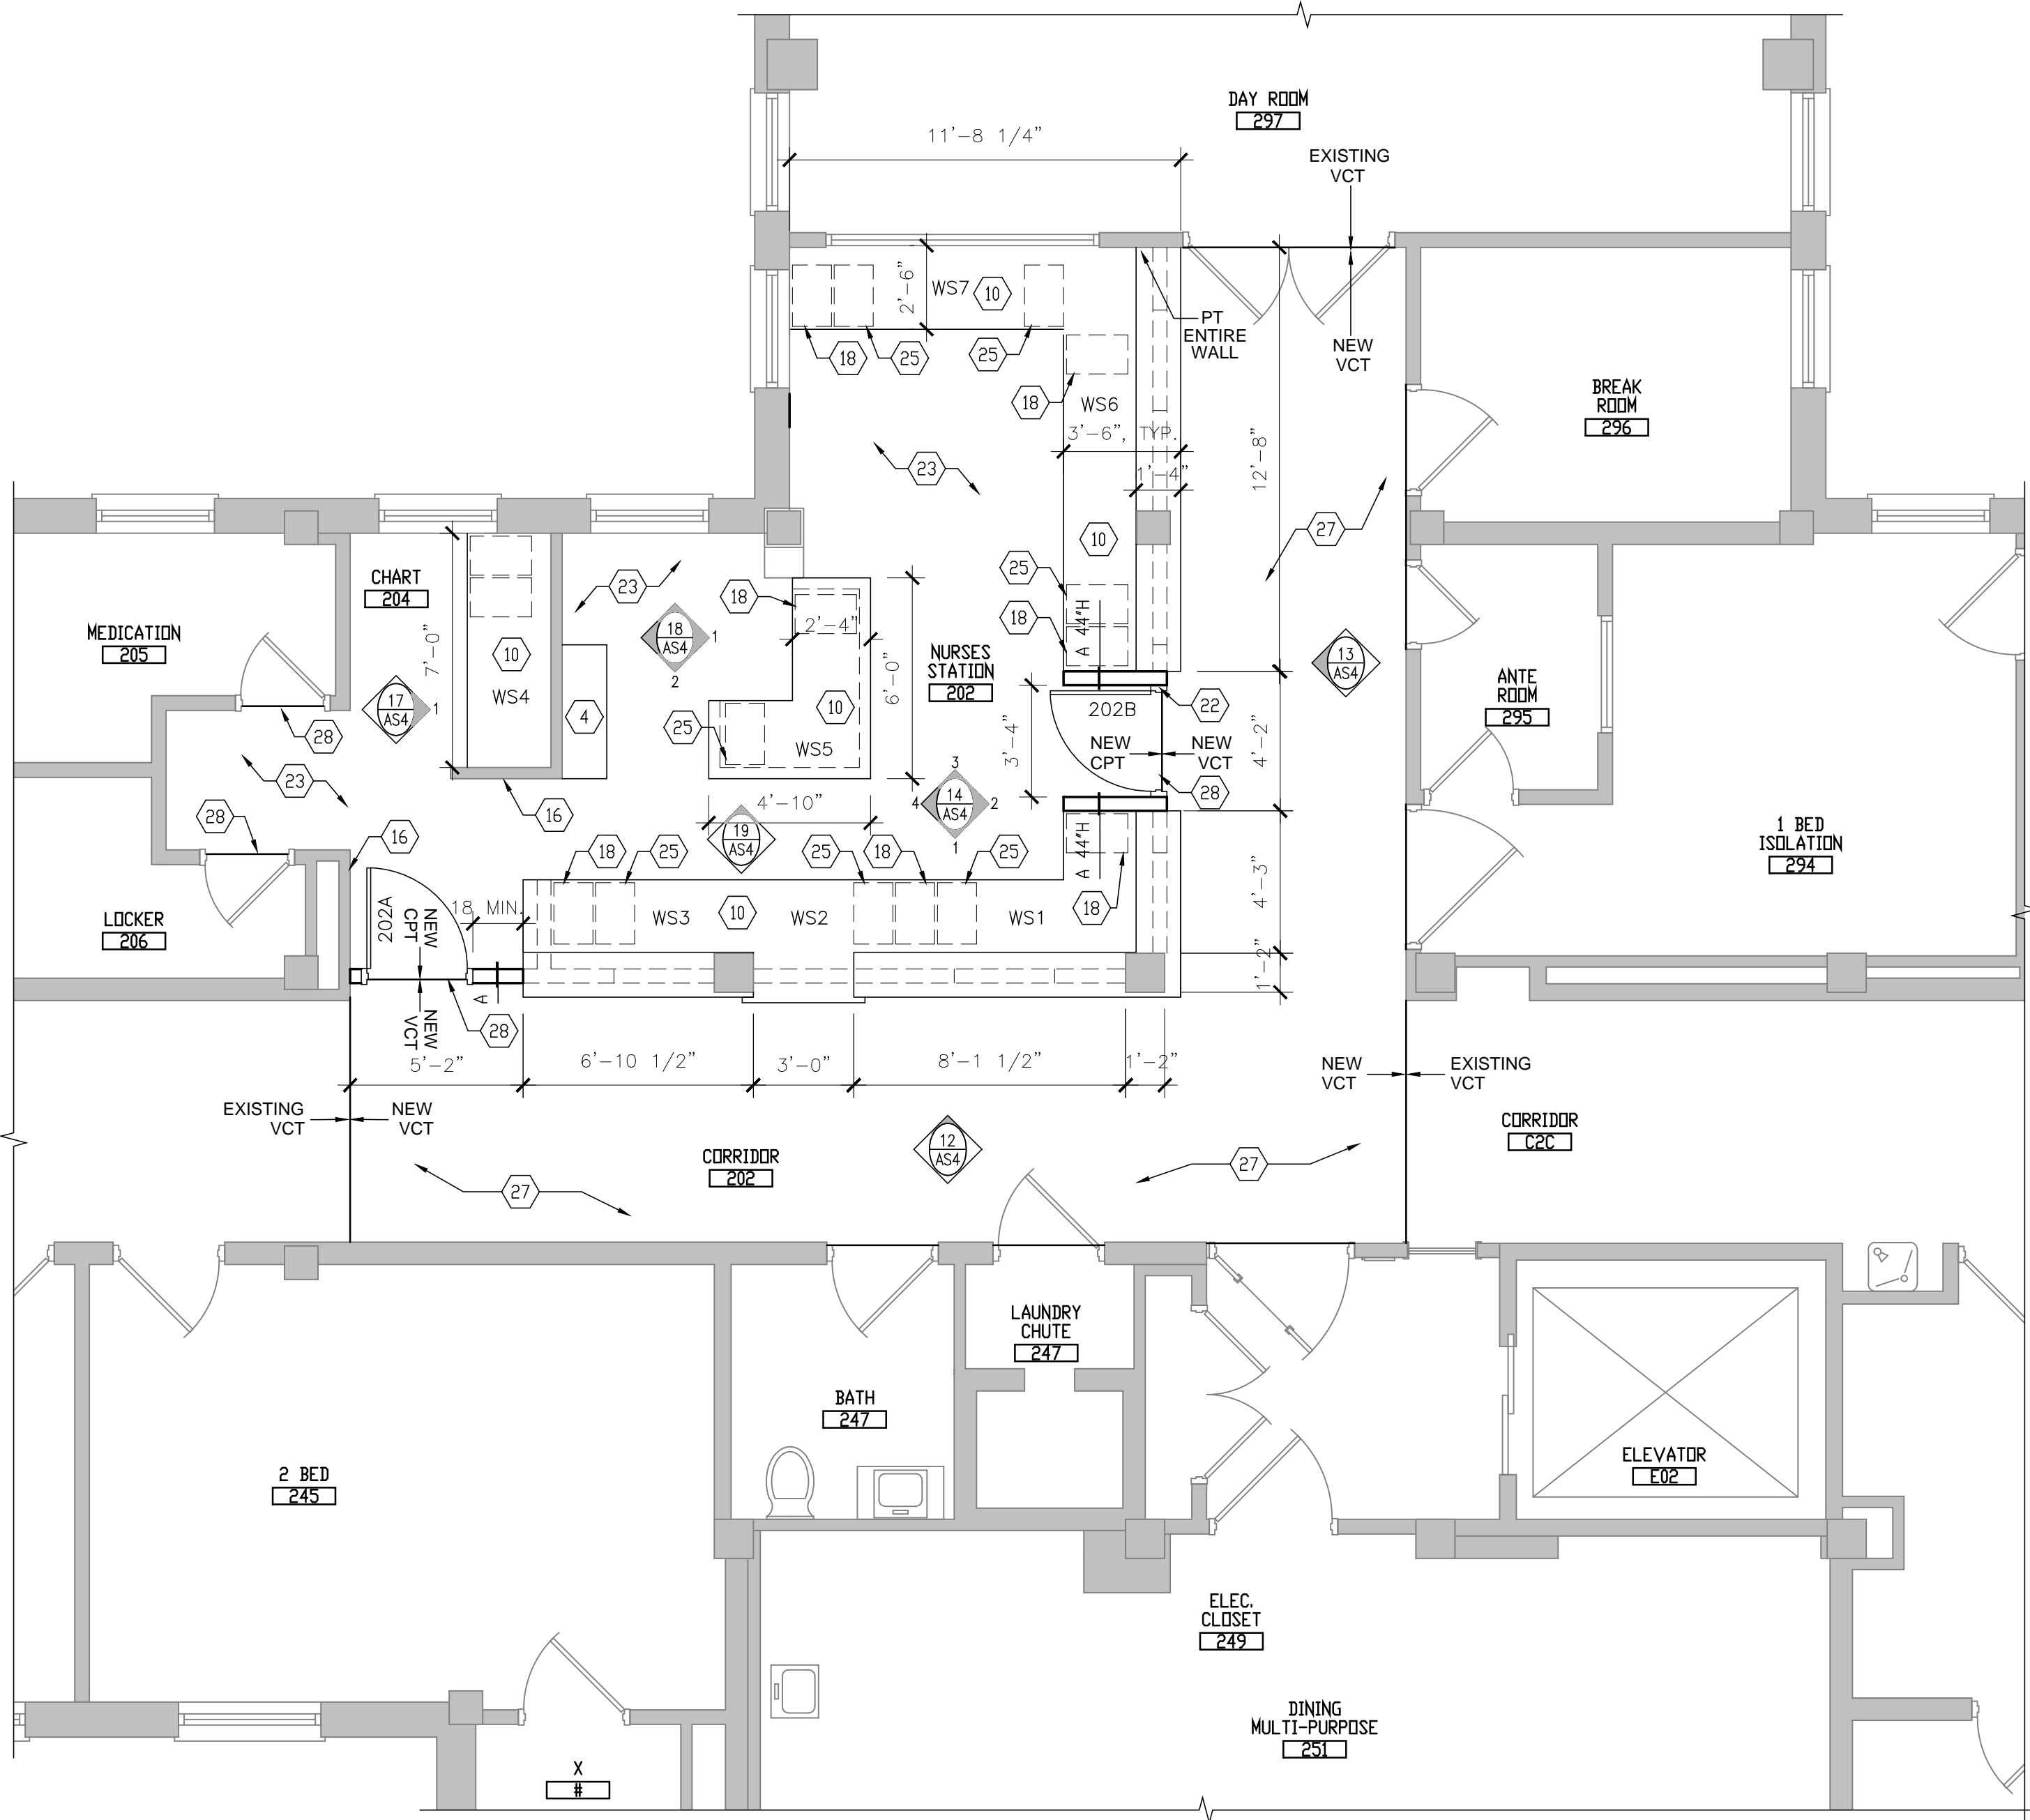
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7. WALL MOUNTED CABINET
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13. REUSE BUILDING DIRECTORY
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32. NEW INTELEX MONITORING SYSTEM LOCATION. RUN CABELING IN CONDUIT PLACED IN NORTH SIDE OF COLUMN FURRING.
33. MAINTAIN EGRESS ROUTE THROUGH SPACE AT ALL TIMES DURING FLOORING INSTALLATION
34. BUTT FLOORING MATERIALS SEAMLESS AT TRANSITION

PHASING NOTE: NO MORE THAN 1 NURSE'S STATION IN BUILDING 51 TO BE UNDER CONSTRUCTION AT MORE THAN ONE TIME.



1 BLDG 51: SECOND FLOOR DEMO PLAN - NURSE STATION 202
1/4" = 1'-0"



2 BLDG 51: SECOND FLOOR PLAN - NURSE STATION 202
1/4" = 1'-0"

NO	REVISION	DATE

VA FORM 08-6231



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facsimile 320.759.9062
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STAMP/SEAL
I HEREBY CERTIFY THAT THIS PLAN, SPECIFICATIONS, AND REPORTS WERE PREPARED AND THAT I AM A LICENSED ARCHITECT UNDER THE LAWS OF THE STATE OF MINNESOTA.
DANIEL J. MILLER, AIA
DATE: 09.15.2013
RES. NO.


DRAWING TITLE
BUILDING 51, SECOND FLOOR DEMO & REVISED PLAN

PROJECT TITLE
UPGRADE RECEPTION STATIONS BLDGS 2 & 51
BUILDING No: 51
ORDERED BY: RWM
DRAWN: NJE
CAN FILE: B51-2.DWG
LOCATION: VA MEDICAL CENTER ST CLOUD, MN 56303
DRAWING NO: ASS
DATE: 09.15.2013
REV. NO: 4 OF 21

DATE: 09.15.2013
PROJECT SCALE: AS NOTED
PROJECT NO: 656-13-226



three eighths inch = one foot
one eighth inch = one foot
one quarter inch = one foot
one half inch = one foot
three quarters inch = one foot
one inch = one foot
one and one half inches = one foot
two inches = one foot
three inches = one foot
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eight inches = one foot
nine inches = one foot
ten inches = one foot
eleven inches = one foot
twelve inches = one foot
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seventy three inches = one foot
seventy four inches = one foot
seventy five inches = one foot
seventy six inches = one foot
seventy seven inches = one foot
seventy eight inches = one foot
seventy nine inches = one foot
eighty inches = one foot
eighty one inches = one foot
eighty two inches = one foot
eighty three inches = one foot
eighty four inches = one foot
eighty five inches = one foot
eighty six inches = one foot
eighty seven inches = one foot
eighty eight inches = one foot
eighty nine inches = one foot
ninety inches = one foot
ninety one inches = one foot
ninety two inches = one foot
ninety three inches = one foot
ninety four inches = one foot
ninety five inches = one foot
ninety six inches = one foot
ninety seven inches = one foot
ninety eight inches = one foot
ninety nine inches = one foot
one hundred inches = one foot

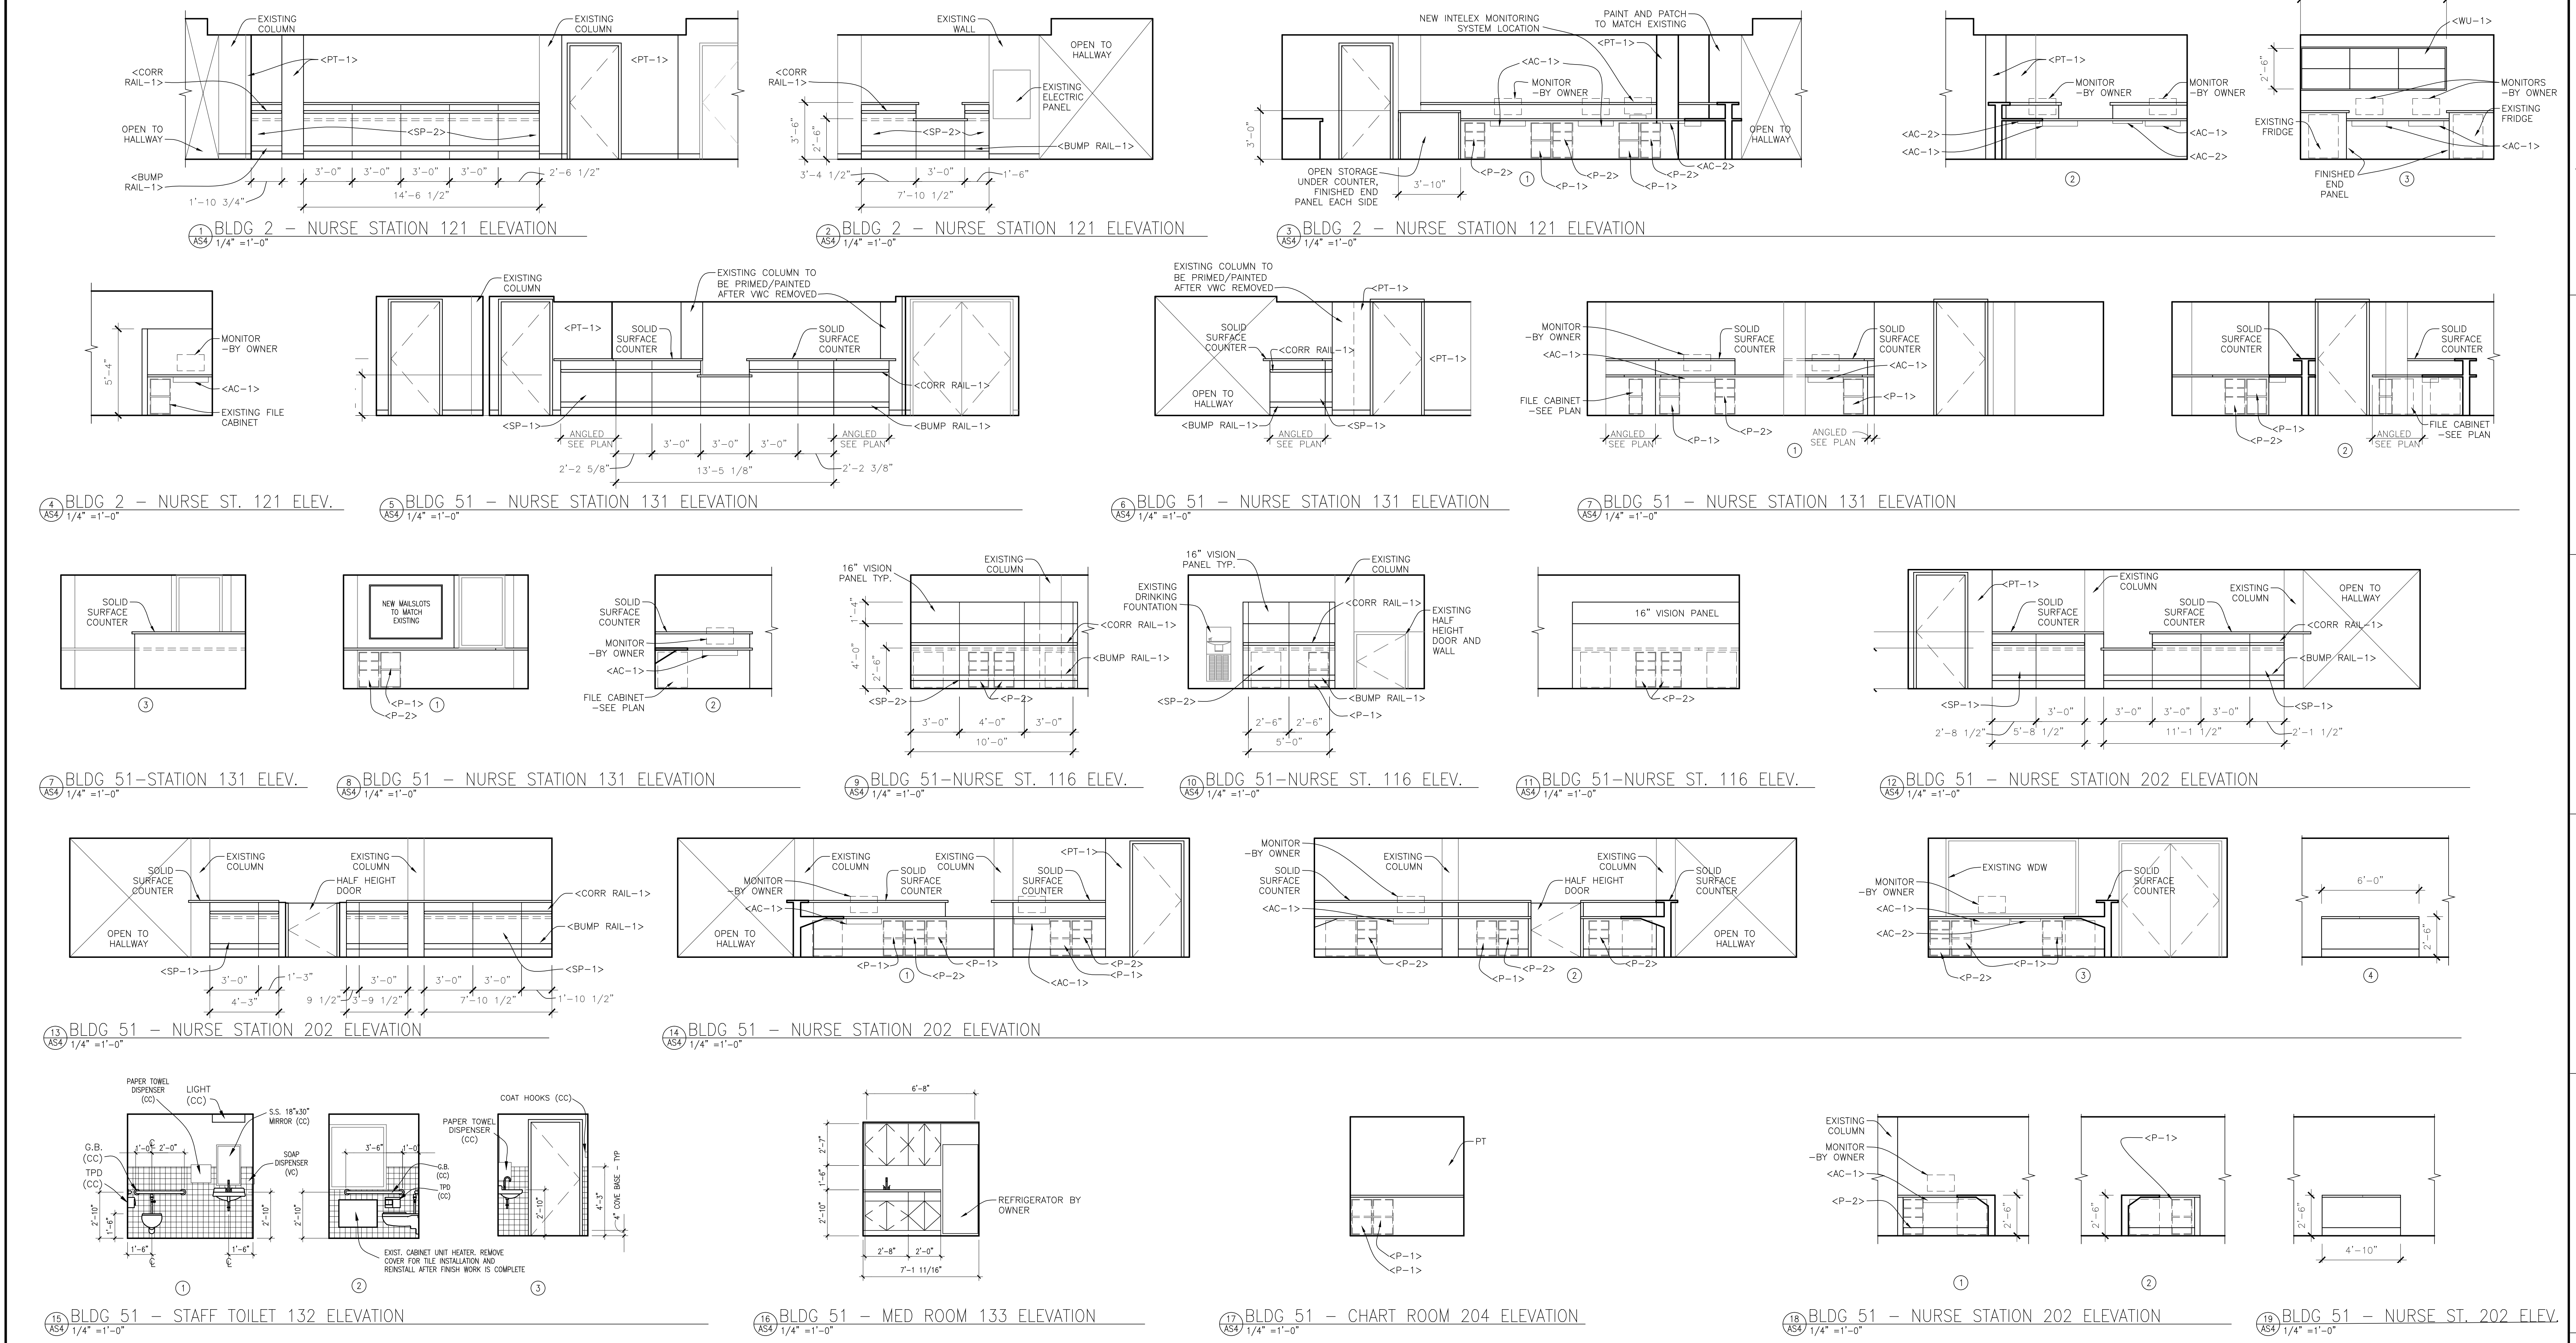

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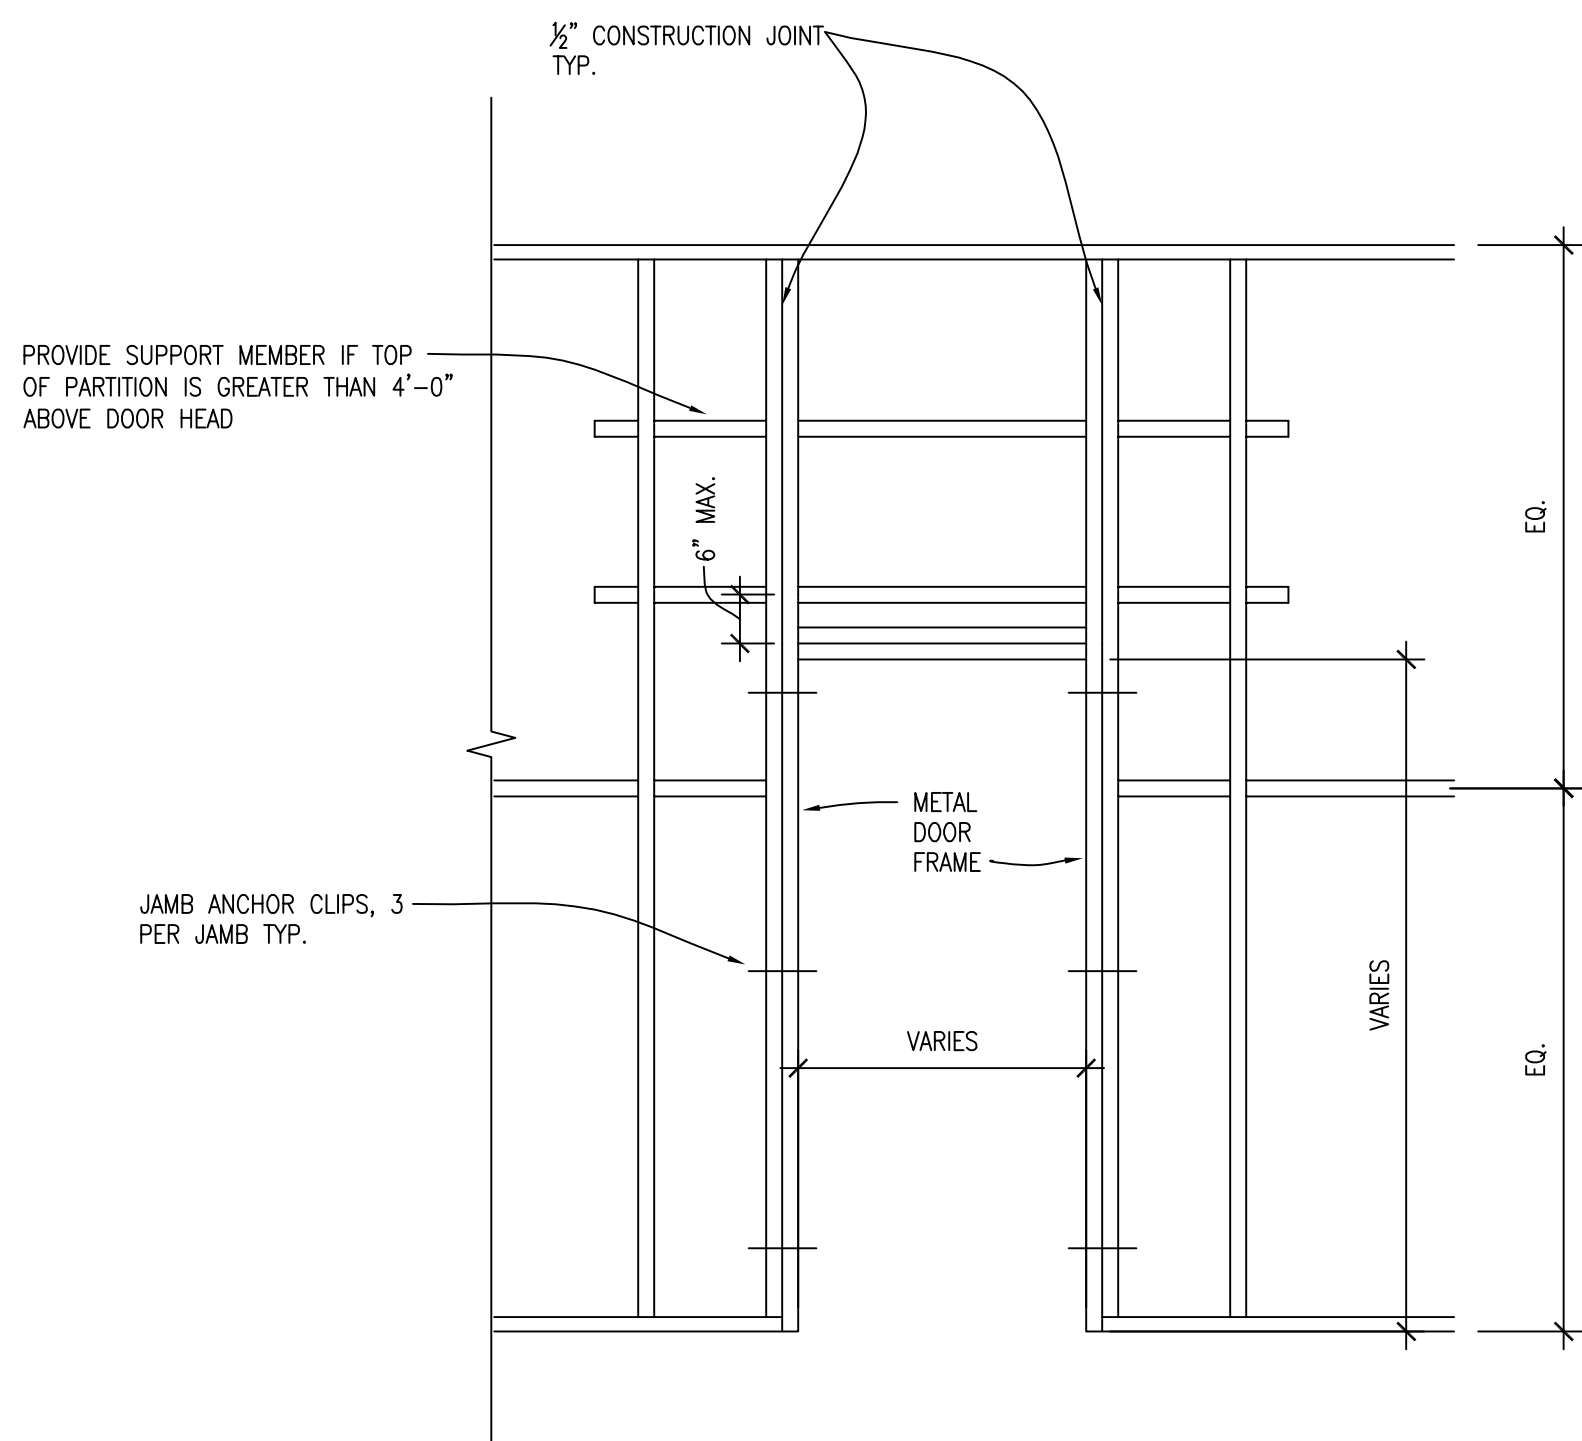
three inches = one foot
one and one half inches = one foot
one inch = one foot
three quarters inch = one foot
one half inch = one foot
three eighths inch = one foot
one quarter inch = one foot
one eighth inch = one foot

6 CUSTOM NURSE STATION SECTION
ASS 3/4" = 1'-0"
STATION #131, 202


NO	REVISION	DATE

5 STANDARD NURSE STATION SECTION
ASS 3/4" = 1'-0"
STATION #121, 116

4 DOOR HEAD & JAMB TYP.
ASS 3" = 1'-0"



3 FRAMING AT DOOR OPENING TYP.
ASS 1/2" = 1'-0"

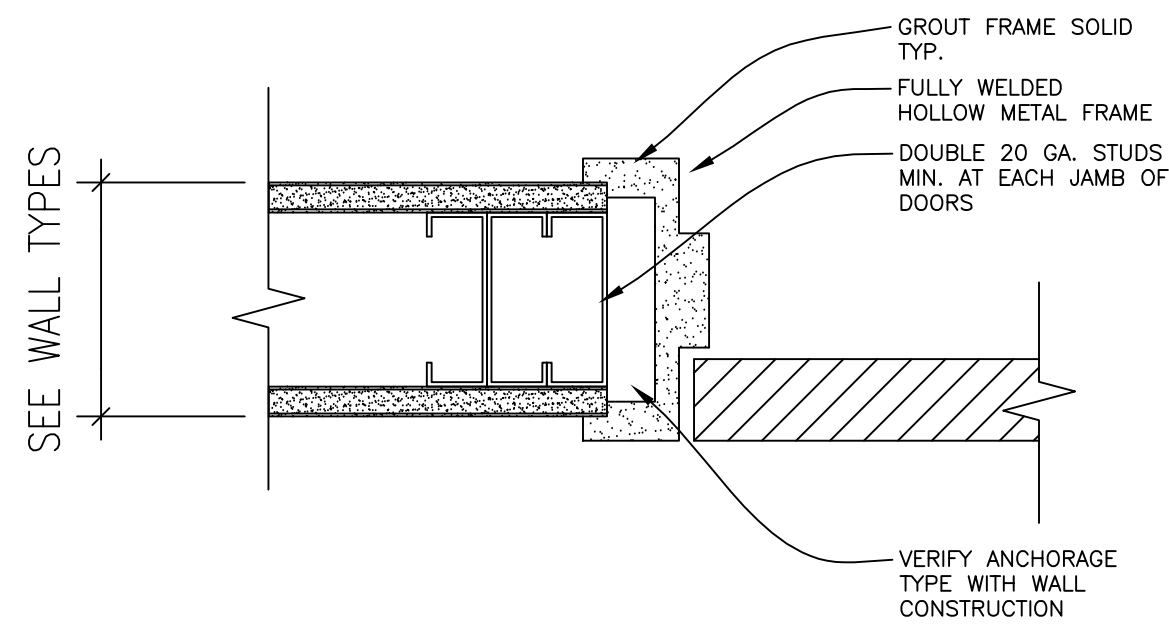

ROOM FINISH SCHEDULE

ROOM NUMBER	BUILDING NUMBER	ROOM NAME	FLOOR FINISH	BASE FINISH	WALL FINISH				CEILING FINISH	COMMENTS
					EAST	NORTH	SOUTH	WEST		
101A	2	OFFICE	CPT	CPT	PT	PT	PT	PT	SEE RCP	PT WALL AT CORRIDOR SIDE OF CONSTRUCTION
121	2	RECEPTION STATION	CPT	CPT	PT	PT	PT	PT	SEE RCP	PAINT COLUMNS, ALL SIDES, PT SOFFIT
116	51	NURSES STATION	-	-	PT	PT	PT	-	PT	PT WALLS, COLUMNS, AND SOFFIT
129	51	RECREATION	RBF	VB	-	-	-	-	SEE RCP	-
131	51	NURSES STATION	CPT	CPT	PT	PT	PT	PT	SEE RCP	PT WALLS, COLUMNS, AND SOFFIT
131	51	CORRIDOR	VCT	RB	PT	PT	PT	PT	SEE RCP	-
132	51	STAFF TOILET	CER-TILE	TILE BASE	CER-TILE/PT	CER-TILE/PT	CER-TILE/PT	CER-TILE/PT	SEE RCP	51" CER-TILE MANSOOT TYP.
133	51	MEDICATION ROOM	VCT	VB	PT	PT	PT	PT	SEE RCP	-
202	51	NURSES STATION	CPT	CPT	PT	PT	PT	PT	SEE RCP	PAINT COLUMNS, WALLS, AND SOFFIT
202	51	CORRIDOR	VCT	VB	-	-	-	-	SEE RCP	-
204	51	CHART ROOM	CPT	CPT	PT	PT	PT	PT	SEE RCP	-

*NOTE: UP TO (4) PAINT COLORS MAY BE CHOSEN FOR USE ACROSS THE ENTIRE PROJECT

MATERIALS SCHEDULE

MARK	SPEC SECTION	MATERIAL DESCRIPTION	MANUFACTURER	PRODUCT	COLOR/FINISH	SIZE	SPECIAL INSTRUCTIONS	LOCATION COMMENTS
ACT-1	085100	ACOUSTICAL CEILING TILE	USG	SQUARE, FISSED EDGE	WHITE	24"x24"	-	CEILING THROUGHOUT
CPT TILE	096800	CARPET TILE	MILLIKEN	COLORWEAVE COLORED CRYSTAL	208 EMERALD GREEN	28"x36"	-	-
CPT BASE	096800	CARPET BASE	-	-	-	4" HT.	HEMMED EDGE	-
CER TILE-10	093000	CERAMIC FLOOR TILE	AMERICAN OLEAN	UNGLAZED COLORBODY PORCELAIN	ALMOND A24	2"x2" MOSAIC	-	STAFF TOILET 132
CER TILE-20	093000	CERAMIC WALL TILE	AMERICAN OLEAN	GLAZED WALL TILE	SNOW MIST 0095	4 1/4" x 4 1/4"	BULLNOSE CAP AT MANSOOT	STAFF TOILET 132
CER BASE	093000	COVE TILE BASE	AMERICAN OLEAN	GLAZED WALL TILE	SNOW MIST	-	-	STAFF TOILET 132
GROUT 1	097000	FLOOR GROUT	-	TBD	GRAY	-	-	TILE GROUT AT CERAMIC FLOORS
GROUT 2	097000	WALL GROUT	-	TBD	OFF-WHITE	-	-	TILE GROUT AT CERAMIC WALL TILE
KP-1	087100/102600	VINYL KICKPLATE	INPRO CORP	TBD	TBD FROM MFRS. STANDARD	-	-	DOOR ARMOR PROTECTION
PLAM-1	123600	PLASTIC LAMINATE	WILSONART	TBD	SHAWER CHERRY 7935-07	-	SELF ADHERED	PANEL ON SYSTEM FURNITURE <SP-1>
PT-1	099000	INTERIOR/LOW VOC PAINT	BENJAMIN MOORE	ECO SPEC	TBD	-	PT	WALLS/SOFFITS THROUGHOUT
RBF-1	096500	RUBBER FLOORING	JOHNSONITE	RUBBER FLOOR TILE	712 CURRY	24" x 24"	HAMMERED FINISH TEXTURE	RECREATION 129, FIELD COLOR
RBF-2	096500	RUBBER FLOORING	JOHNSONITE	RUBBER FLOOR TILE	47 BROWN	24" x 24"	HAMMERED FINISH TEXTURE	RECREATION 129, WALKWAY COLOR
VB	096500	VINYL BASE	JOHNSONITE	VB	TBD	4" HT.	MATCH EXIST. COLOR	VCT FLOOR LOCATIONS THROUGHOUT
VCT	096500	VINYL COMPOSITE TILE	ARMSTRONG	TBD	FORTRESS WHITE 51839	12"x12"	-	CORRIDOR LOCATIONS
S SURF	123600	SOLID POLYMER FABRICATION	CORIAN	TBD	LINEN	1/2" THK	-	UPPER WORK SURFACE OF <SP-1>

NOTE: MATERIALS SCHEDULE REPRESENTS BASIS OF DESIGN PRODUCTS

EQUIPMENT SCHEDULE

NUMBER/MARK	NAME	SIZE	SPEC. SECTION	LOCATIONS	BASIS OF DESIGN	REMARKS
SP-1	SYSTEM PANEL	SEE ELEVATIONS	125900	STATIONS 131, 202	HERMAN MILLER ETHOSPACE	PLAM-1 WALL PANEL, SLATE GREY BASE, WORK SURFACE: SOFT WHITE, UPPER WORK SURFACES <S SURF>
SP-2	SYSTEM PANEL	SEE ELEVATIONS	125900	STATIONS 121, 116	HERMAN MILLER NURSES STATION	PANEL FABRIC GOSWAMER 9232, SLATE GREY BASE, SOFT WHITE WORK SURFACES
P-1	FILE/FILE PEDESTAL	15"W x 23 1/2"H x 22"D	125900	SEE ELEVATIONS	HERMAN MILLER MERIDIAN PEDESTAL M-16	PROVIDE CASTERS, COLOR SOFT WHITE
P-2	BOX/BOX/FILE PEDESTAL	15"W x 23 1/2"H x 22"D	125900	SEE ELEVATIONS	HERMAN MILLER MERIDIAN PEDESTAL M-16	PROVIDE CASTERS, COLOR SOFT WHITE
MU-1	WALL MOUNT STORAGE	36"W x 15"H x 16"D	125900	SEE ELEVATIONS	HERMAN MILLER C-STYLE FLUPPER DOOR UNIT X3710	COLOR SOFT WHITE
AC-1	KEYBOARD TRAY	-	125900	SEE ELEVATIONS	HERMAN MILLER LS SERIES KEYBOARD TRAY Y7737	-
AC-2	PENCIL DRAWER	-	125900	SEE ELEVATIONS	HERMAN MILLER PENCIL DRAWER Y5012	-
CORR RAIL-1	HANDRAIL	-	102600	SEE ELEVATIONS	ACRODYN HR-60N	COLOR R125
BUMP RAIL-1	BUMPER GUARD	4" HEIGHT	102600	SEE ELEVATIONS	ACRODYN SCR-40N	COLOR R125


NOTE: EQUIPMENT SCHEDULE REPRESENTS BASIS OF DESIGN EQUIPMENT

DOOR SCHEDULE

NUMBER/MARK	NAME	DOOR										FRAME				GLAZING			REMARKS
		SIZE	MATL	DOOR TYPE	MIN. RAT'G	CARD ACCESS	DPI	MHO	HARDWARE GROUP	MATL	FRAME TYPE	MIN. RAT'G	HEAD	JAMB	THRESHOLD	GLAZING	DOORLITE RATING	SIDELITE RATING	
121	N.S. 121 (BLDG 2)	3'-0"x7'-0"x1 3/4"	WD	WD-2	-	-	-	-	HW-20	STEEL	1	-	4/ASS	4/ASS	-	-	-	-	1
131A	N.S. 131 (BLDG 51)	3'-0"x7'-0"x1 3/4"	WD	WD-3	45 MIN	-	-	-	HW-5J	STEEL	1	45 MIN	4/ASS	4/ASS	-	-	-	-	1
131B	N.S. 131 (BLDG 51)	3'-0"x7'-0"x1 3/4"	WD	WD-2	-	-	-	-	HW-20	STEEL	1	-	4/ASS	4/ASS	-	-	-	-	1
131C	N.S. 131 (BLDG 51)	3'-0"x7'-0"x1 3/4"	WD	WD-2	-	-	-	-	HW-20	STEEL	1	-	4/ASS	4/ASS	-	-	-	-	1
132	N.S. 131 RESTROOM (51)	3'-0"x7'-0"x1 3/4"	WD	WD-1	-	-	-	-	HW-2F	STEEL	1	-	4/ASS	4/ASS	-	-	-	-	-
202A	N.S. 202 (BLDG 51)	3'-0"x7'-0"x1 3/4"	WD	WD-2	-	-	-	-	HW-20	STEEL	1	-	4/ASS	4/ASS	-	-	-	-	1
202B	N.S. 202 (BLDG 51)	3'-0"x3'-6"x1 3/4"	WD	WD-4	-	-	-	-	HW-20	STEEL	2	-	-	4/ASS	-	-	-	-	1

REMARKS:

1) ADHERED VINYL KICKPLATE, PROVIDE WHERE NOTED IN DOOR

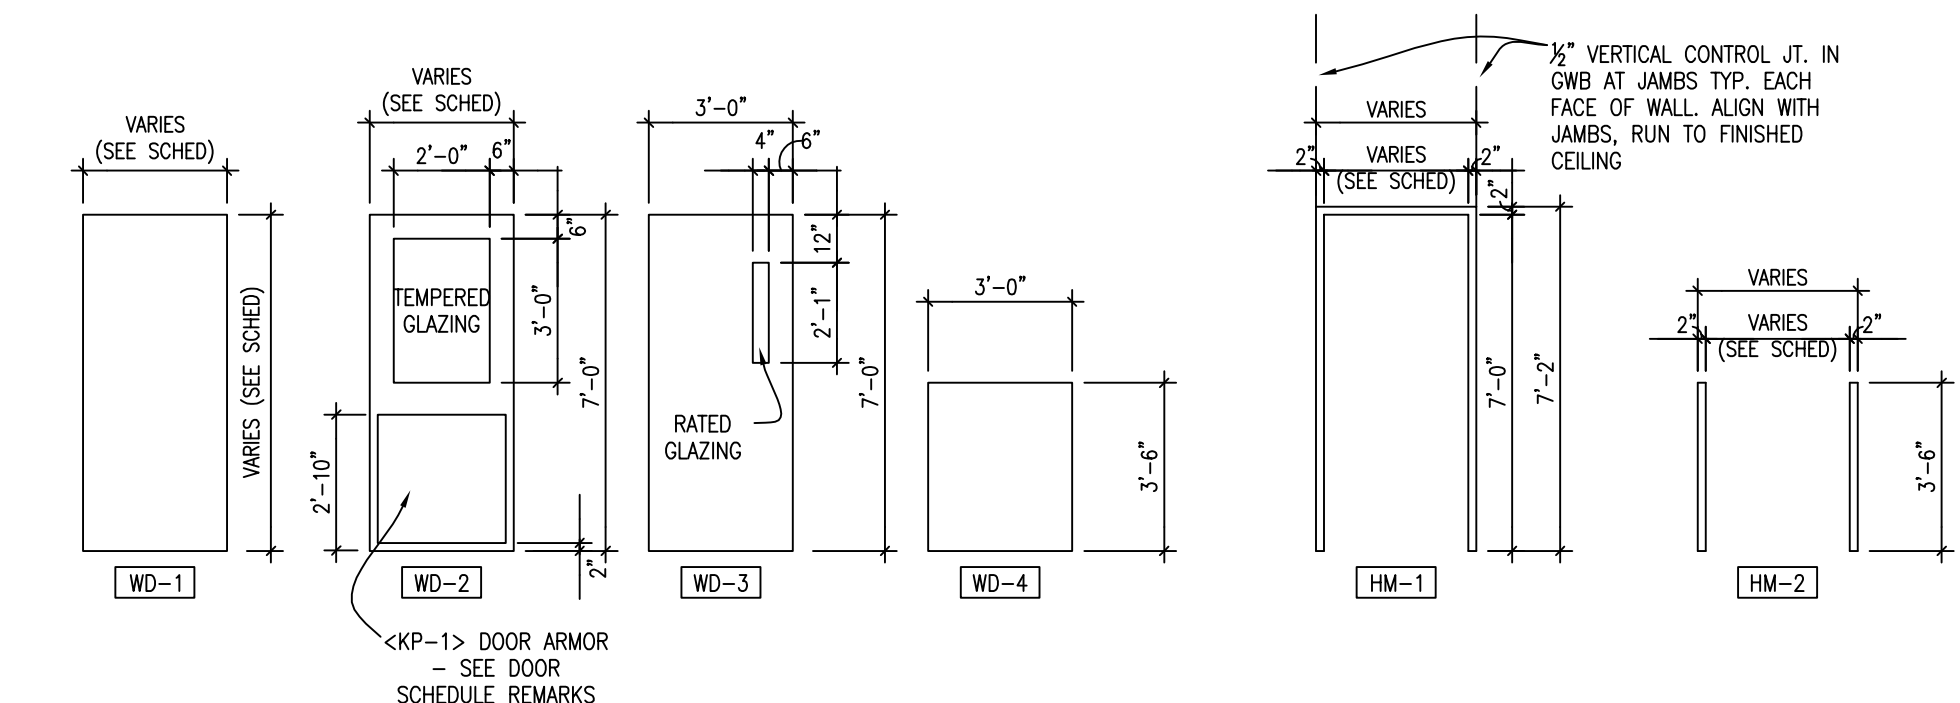

2 DOOR ELEVATIONS
ASS 1/4" = 1'-0"

1 DOOR FRAME ELEVATIONS
ASS 1/4" = 1'-0"

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DANIEL J. MILLER, AIA
DATE: 05.15.2013
MIL 43810
REG. NO.

DRAWING TITLE
BUILDING 2 & 51,
DETAILS, SCHEDULES

PROJECT TITLE
UPGRADE RECEPTION STATIONS
BUDGS 2 & 51

DATE
5/15/2013
RUFF SCALE
AS NOTED
PROJECT NO.
656-13-226

BUILDING No.
2 & 51
CHECKED BY
RWM
DRAWN
NJE
CDD FILE
DETAILS.DWG
LOCATION
VA MEDICAL CENTER
ST. CLOUD, MN 56303

DRAWING NO.
ASS
DWG. 6 OF 21



three inches = one foot
one and one half inches = one foot
one inch = one foot
three quarters inch = one foot
one half inch = one foot
three eighths inch = one foot
one quarter inch = one foot
one eighth inch = one foot

GENERAL REFLECTED CEILING PLAN DEMOLITION NOTES:

- A. PATCH AND REPAIR THE EXISTING CEILING PANELS AND GRID WHERE WALLS WERE REMOVED.
B.

REFLECTED CEILING PLAN DEMOLITION KEYNOTES:

1. REMOVE EXISTING SOFFIT CONSTRUCTION AND LIGHT FIXTURES AS REQUIRED FOR NEW CONSTRUCTION. -SEE PLAN
2. REMOVE AND REINSTALL EXISTING ACT FOR NEW WALL CONSTRUCTION. MODIFY TILE AND TRACK AS NECESSARY TO FIT NEW CONFIGURATION.
3. VINYL WALL COVERING (VWC) AT FIRST FLOOR WALLS, COLUMNS, AND SOFFIT AREAS TO BE REMOVED. SKIM COAT SURFACES AND PREP FOR PRIMER AND PAINT.
4. REMOVE ACT AS REQUIRED FOR NEW CONSTRUCTION. -SEE PLAN
5. SEE CONSTRUCTION BARRIER NOTES ON FLOOR PLAN SHEET.
6. RUN CONSTRUCTION BARRIER TO UNDERSIDE OF EXISTING GWB SOFFITS AND SLOPED GWB CEILING AREAS.

GENERAL NOTES:


1. PATCH AND FINISH ANY AREAS DISTURBED BY REMODELING TO MATCH ADJACENT EXISTING FINISHES.
2. ACOUSTIC CEILING TILE TO BE WHITE 2'X2' -SEE SPECS
3. SPRINKLER HEADS TO BE LOCATED IN THE CENTER OF CEILING PANELS TYPICALLY.

REFLECTED CEILING PLAN KEYNOTES:


- 2X2 ACT & GRID
2X4 LAY-IN FLUORESCENT LIGHT FIXTURE
2X4 LAY-IN EMERGENCY POWER FLUORESCENT LIGHT FIXTURE
EXIT SIGN W/ DIRECTIONAL MARKERS
CEILING HEIGHT MARKER
SUPPLY AIR
RETURN AIR
EXHAUST AIR
RECESSED CAN LIGHTING
SPRINKLER LOCATION
SPEAKER LOCATION
CURTAIN TRACK
NURSE CALL LIGHT
BOUNDARY AREA FOR DEDUCT ALTERNATE #2

REFLECTED CEILING PLAN KEYNOTES:

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3. PATCH AT NEW WALL INFILL TO MATCH EXISTING FINISHES
4. NEW SOFFIT, PAINT TO FINISH
5. SKIM COAT EXISTING SOFFIT AFTER VWC REMOVAL. PRIME AND PAINT TO MATCH EXISTING SURFACES.
6. NEW ACT
7. EXISTING SOFFIT TO RECEIVE NEW PAINT
8. REPLACE DISTURBED A.C.T./GRID AND RELOCATED FIXTURES, DEVICES, AND SPRINKLER HEADS THAT WERE TEMPORARILY MOVED DUE TO CONSTRUCTION BARRIER INSTALLATION.

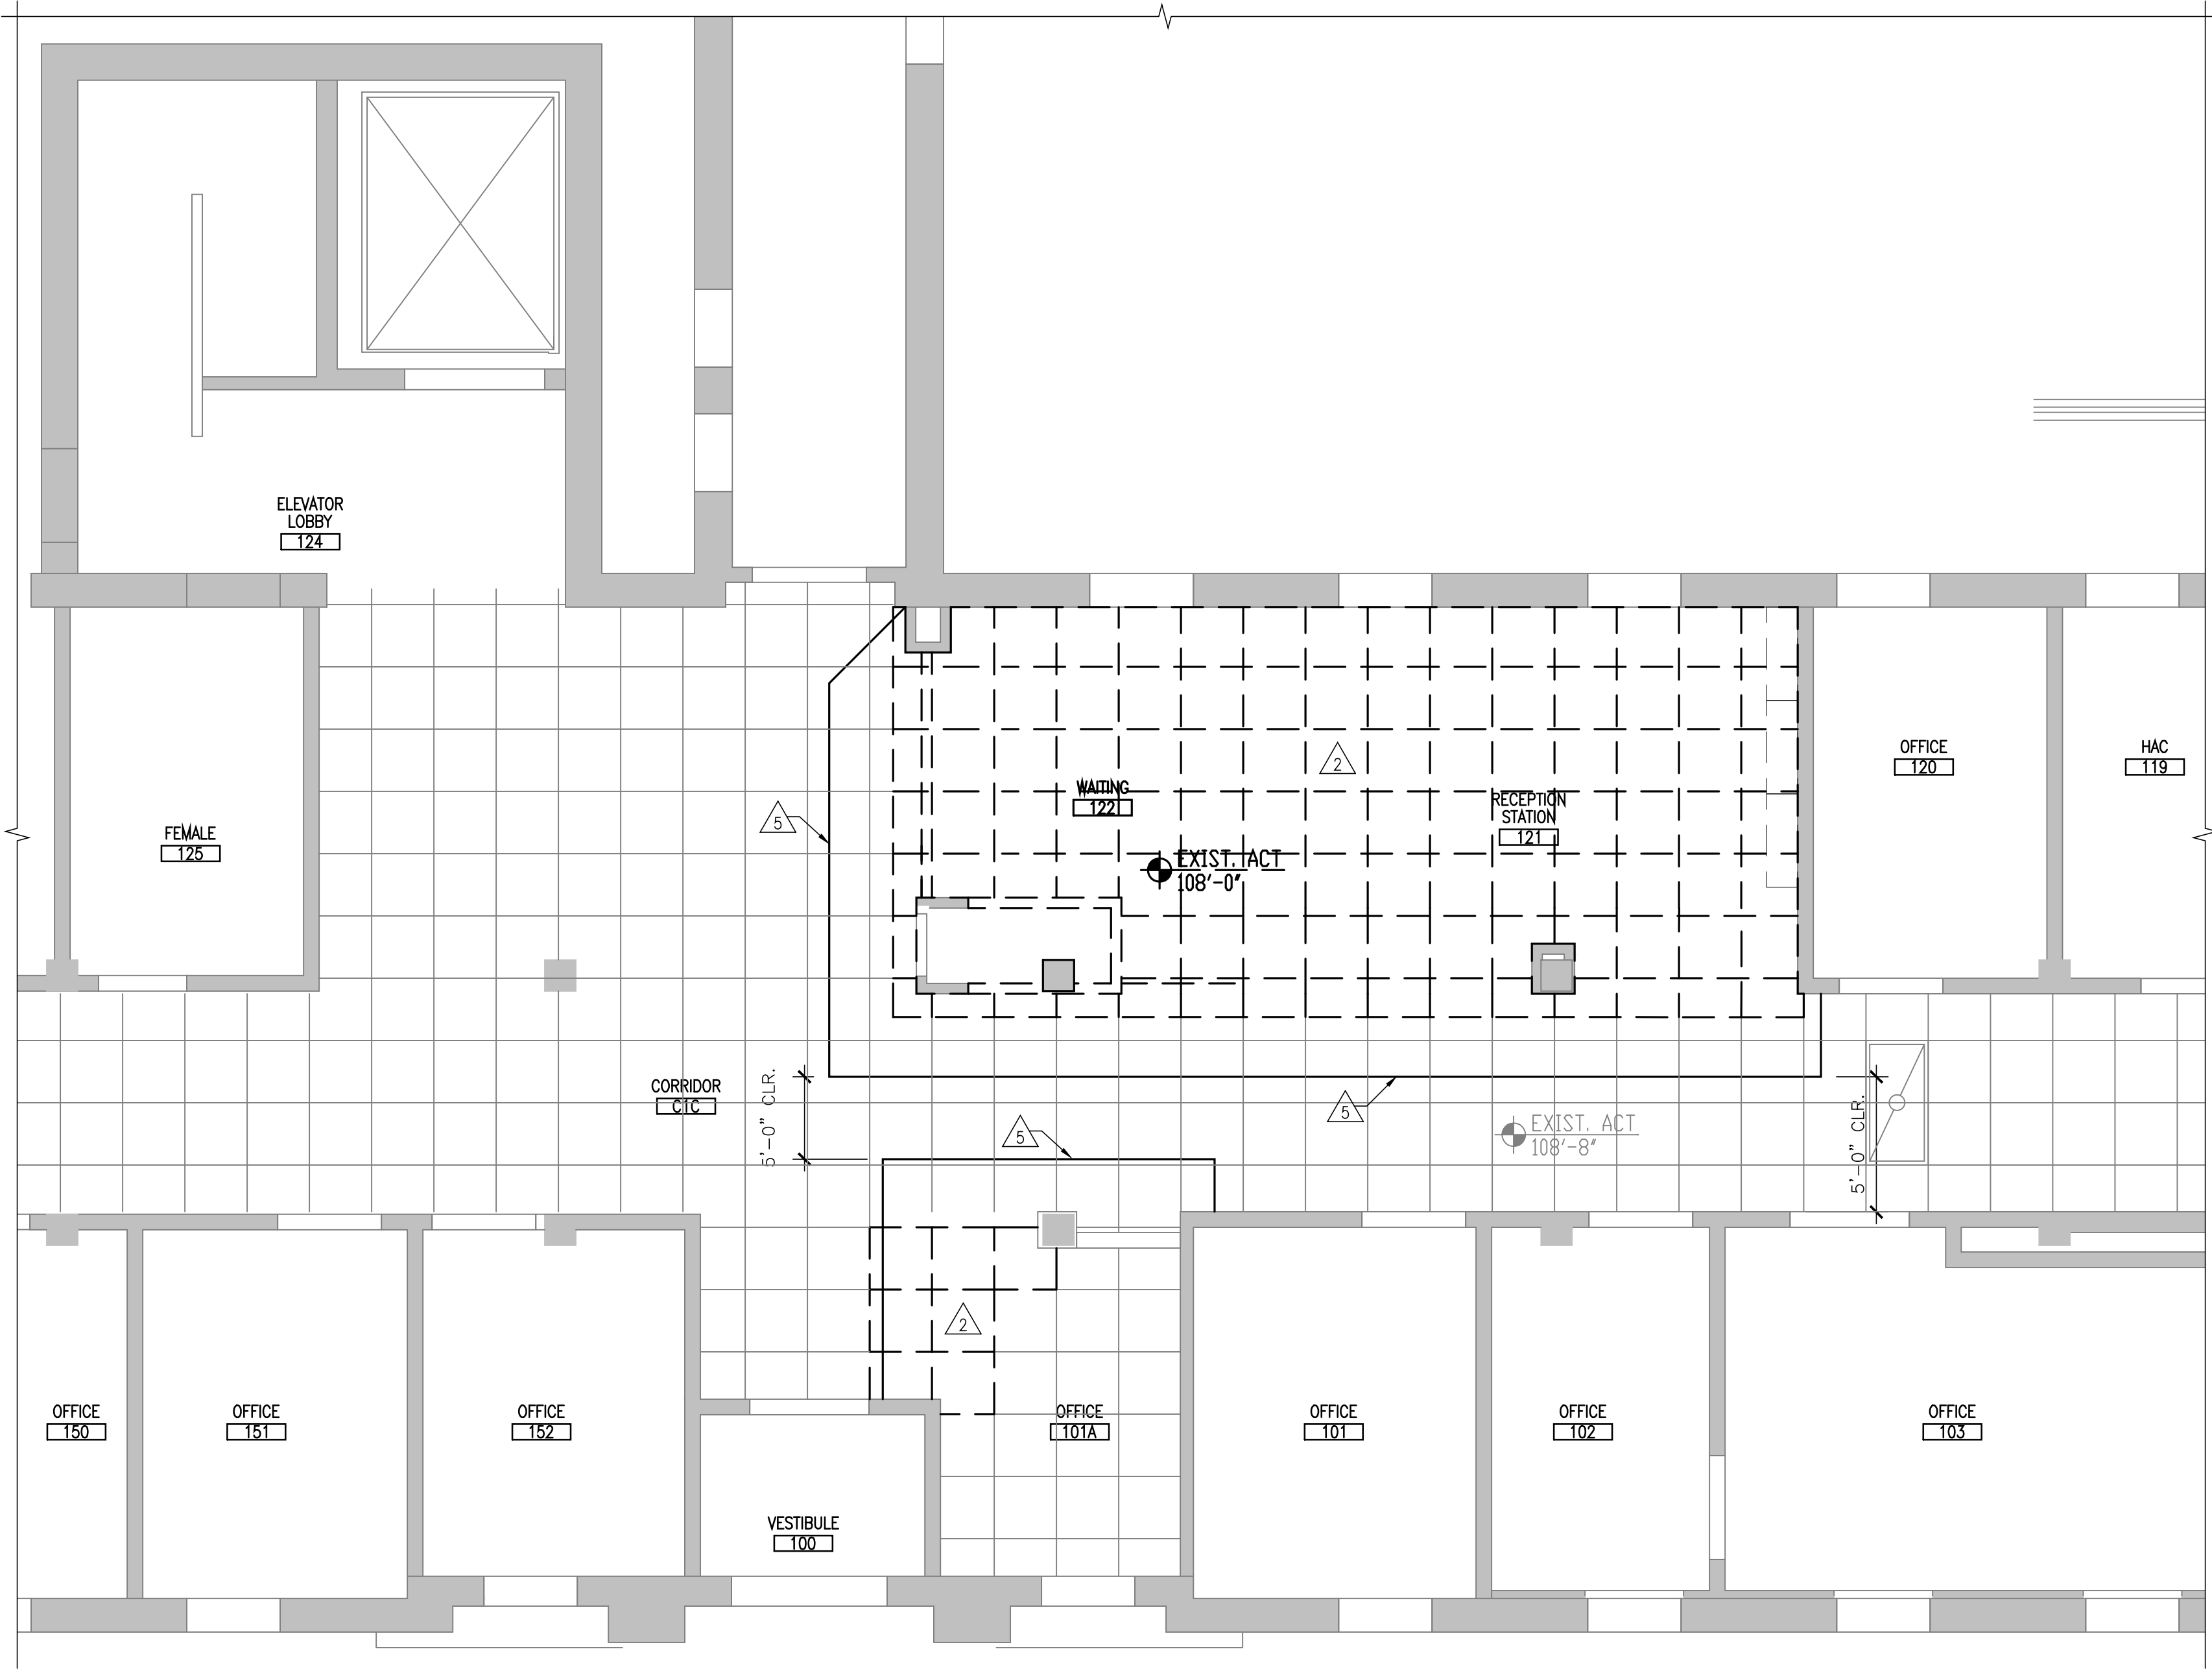

1 BLDG 2: FIRST FLOOR DEMO REFLECTED CEILING PLAN - NURSE STATION 121
1/4" = 1'-0"

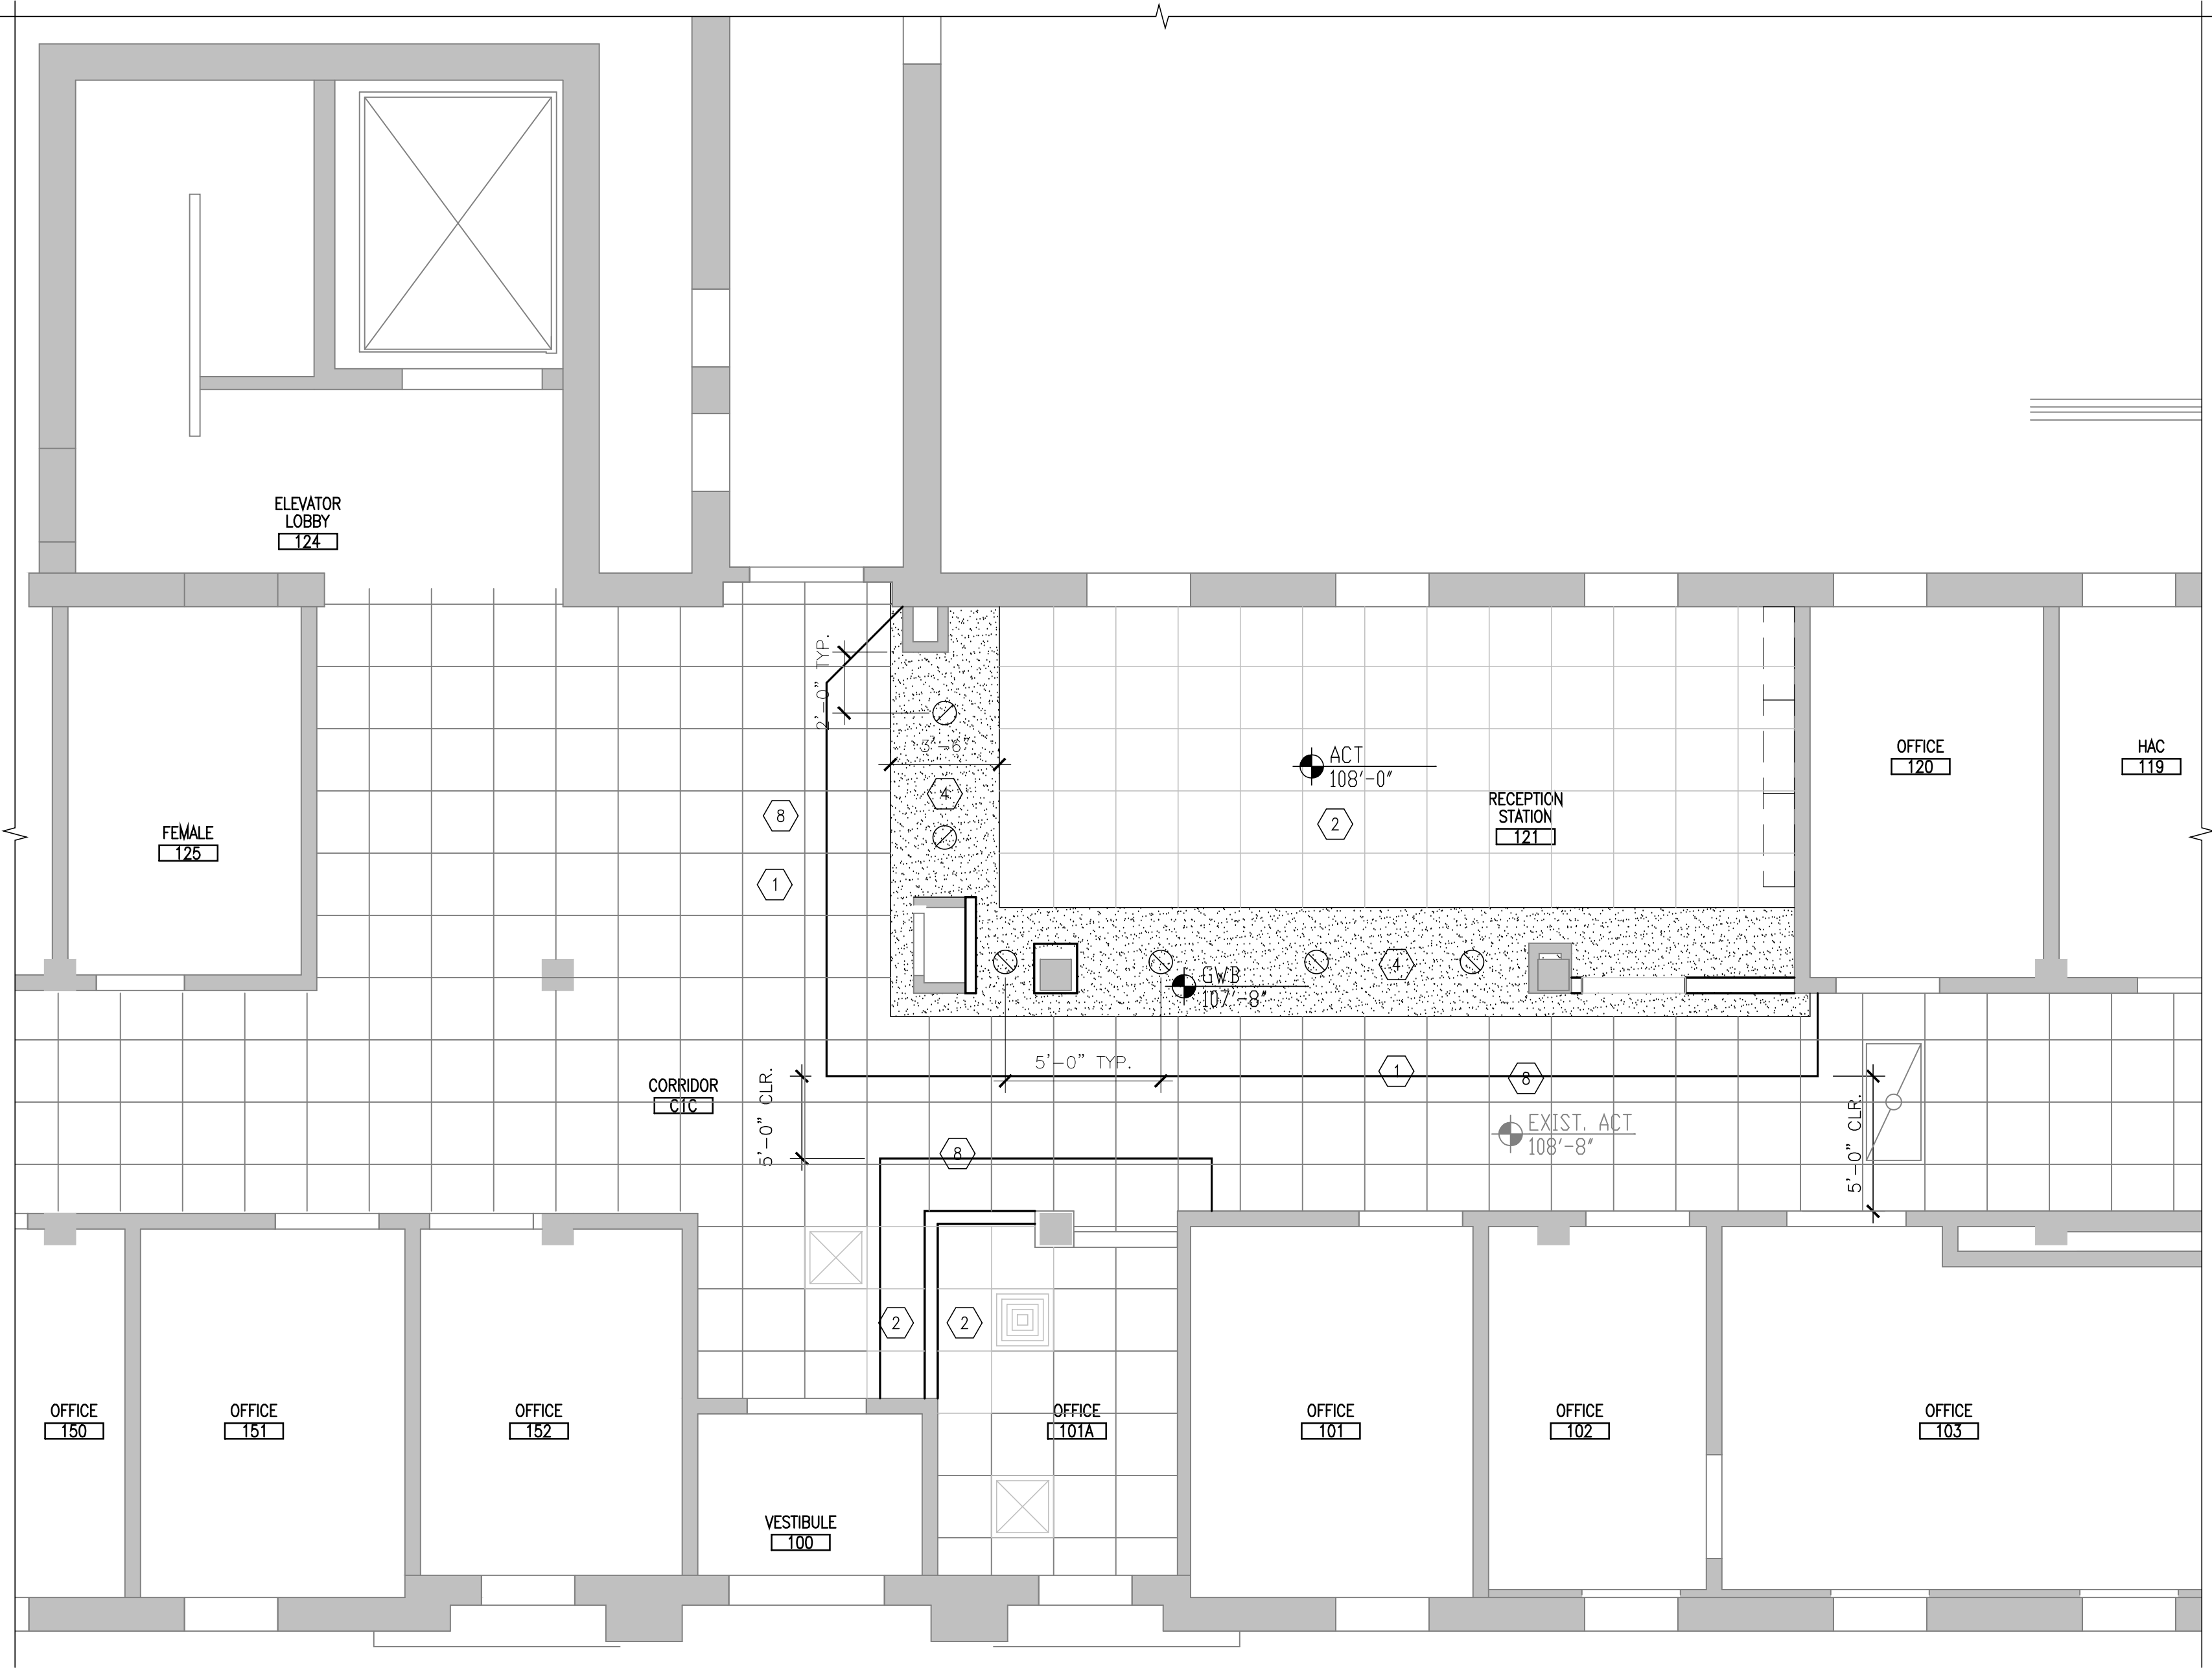

2 BLDG 2: FIRST FLOOR REFLECTED CEILING PLAN - NURSE STATION 121
1/4" = 1'-0"

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No. REVISION DATE		JLG architects Alexandria 525 Broadway Street Alexandria, MN 56308 phone 320.759.9030 facsimile 320.759.9062 www.jlgarchitects.com copyright © 2012		STAMP/SEAL I HEREBY CERTIFY THAT THIS PLAN, SPECIFICATION, AND REPORT WAS PREPARED BY ME OR UNDER MY CLOSE PERSONAL SUPERVISION AND THAT I AM A DULY LICENSED ARCHITECT UNDER THE LAWS OF THE STATE OF MINNESOTA. DANIEL J. MILLER, AIA DATE: 09.15.2013 RES. NO.		DRAWING TITLE BUILDING 2, FIRST FLOOR REFLECTED CEILING PLAN		PROJECT TITLE UPGRADE RECEPTION STATIONS BLDG 2 & 51 PROJECT NO. 656-13-226 CADD FILE AS-5-B2-1-RCP.DWG DRAWING NO. ASE DATE: 09.15.2013 RES. NO. 7 OF 21		St. Cloud VA Health Care System Brainerd Montevideo Alexandria	
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- 4 REMOVE ACT AS REQUIRED FOR NEW CONSTRUCTION. -SEE PLAN
- 5 SEE CONSTRUCTION BARRIER NOTES ON FLOOR PLAN SHEET.
- 6 RUN CONSTRUCTION BARRIER TO UNDERSIDE OF EXISTING GWB SOFFITS AND SLOPED GWB CEILING AREAS.

GENERAL NOTES:


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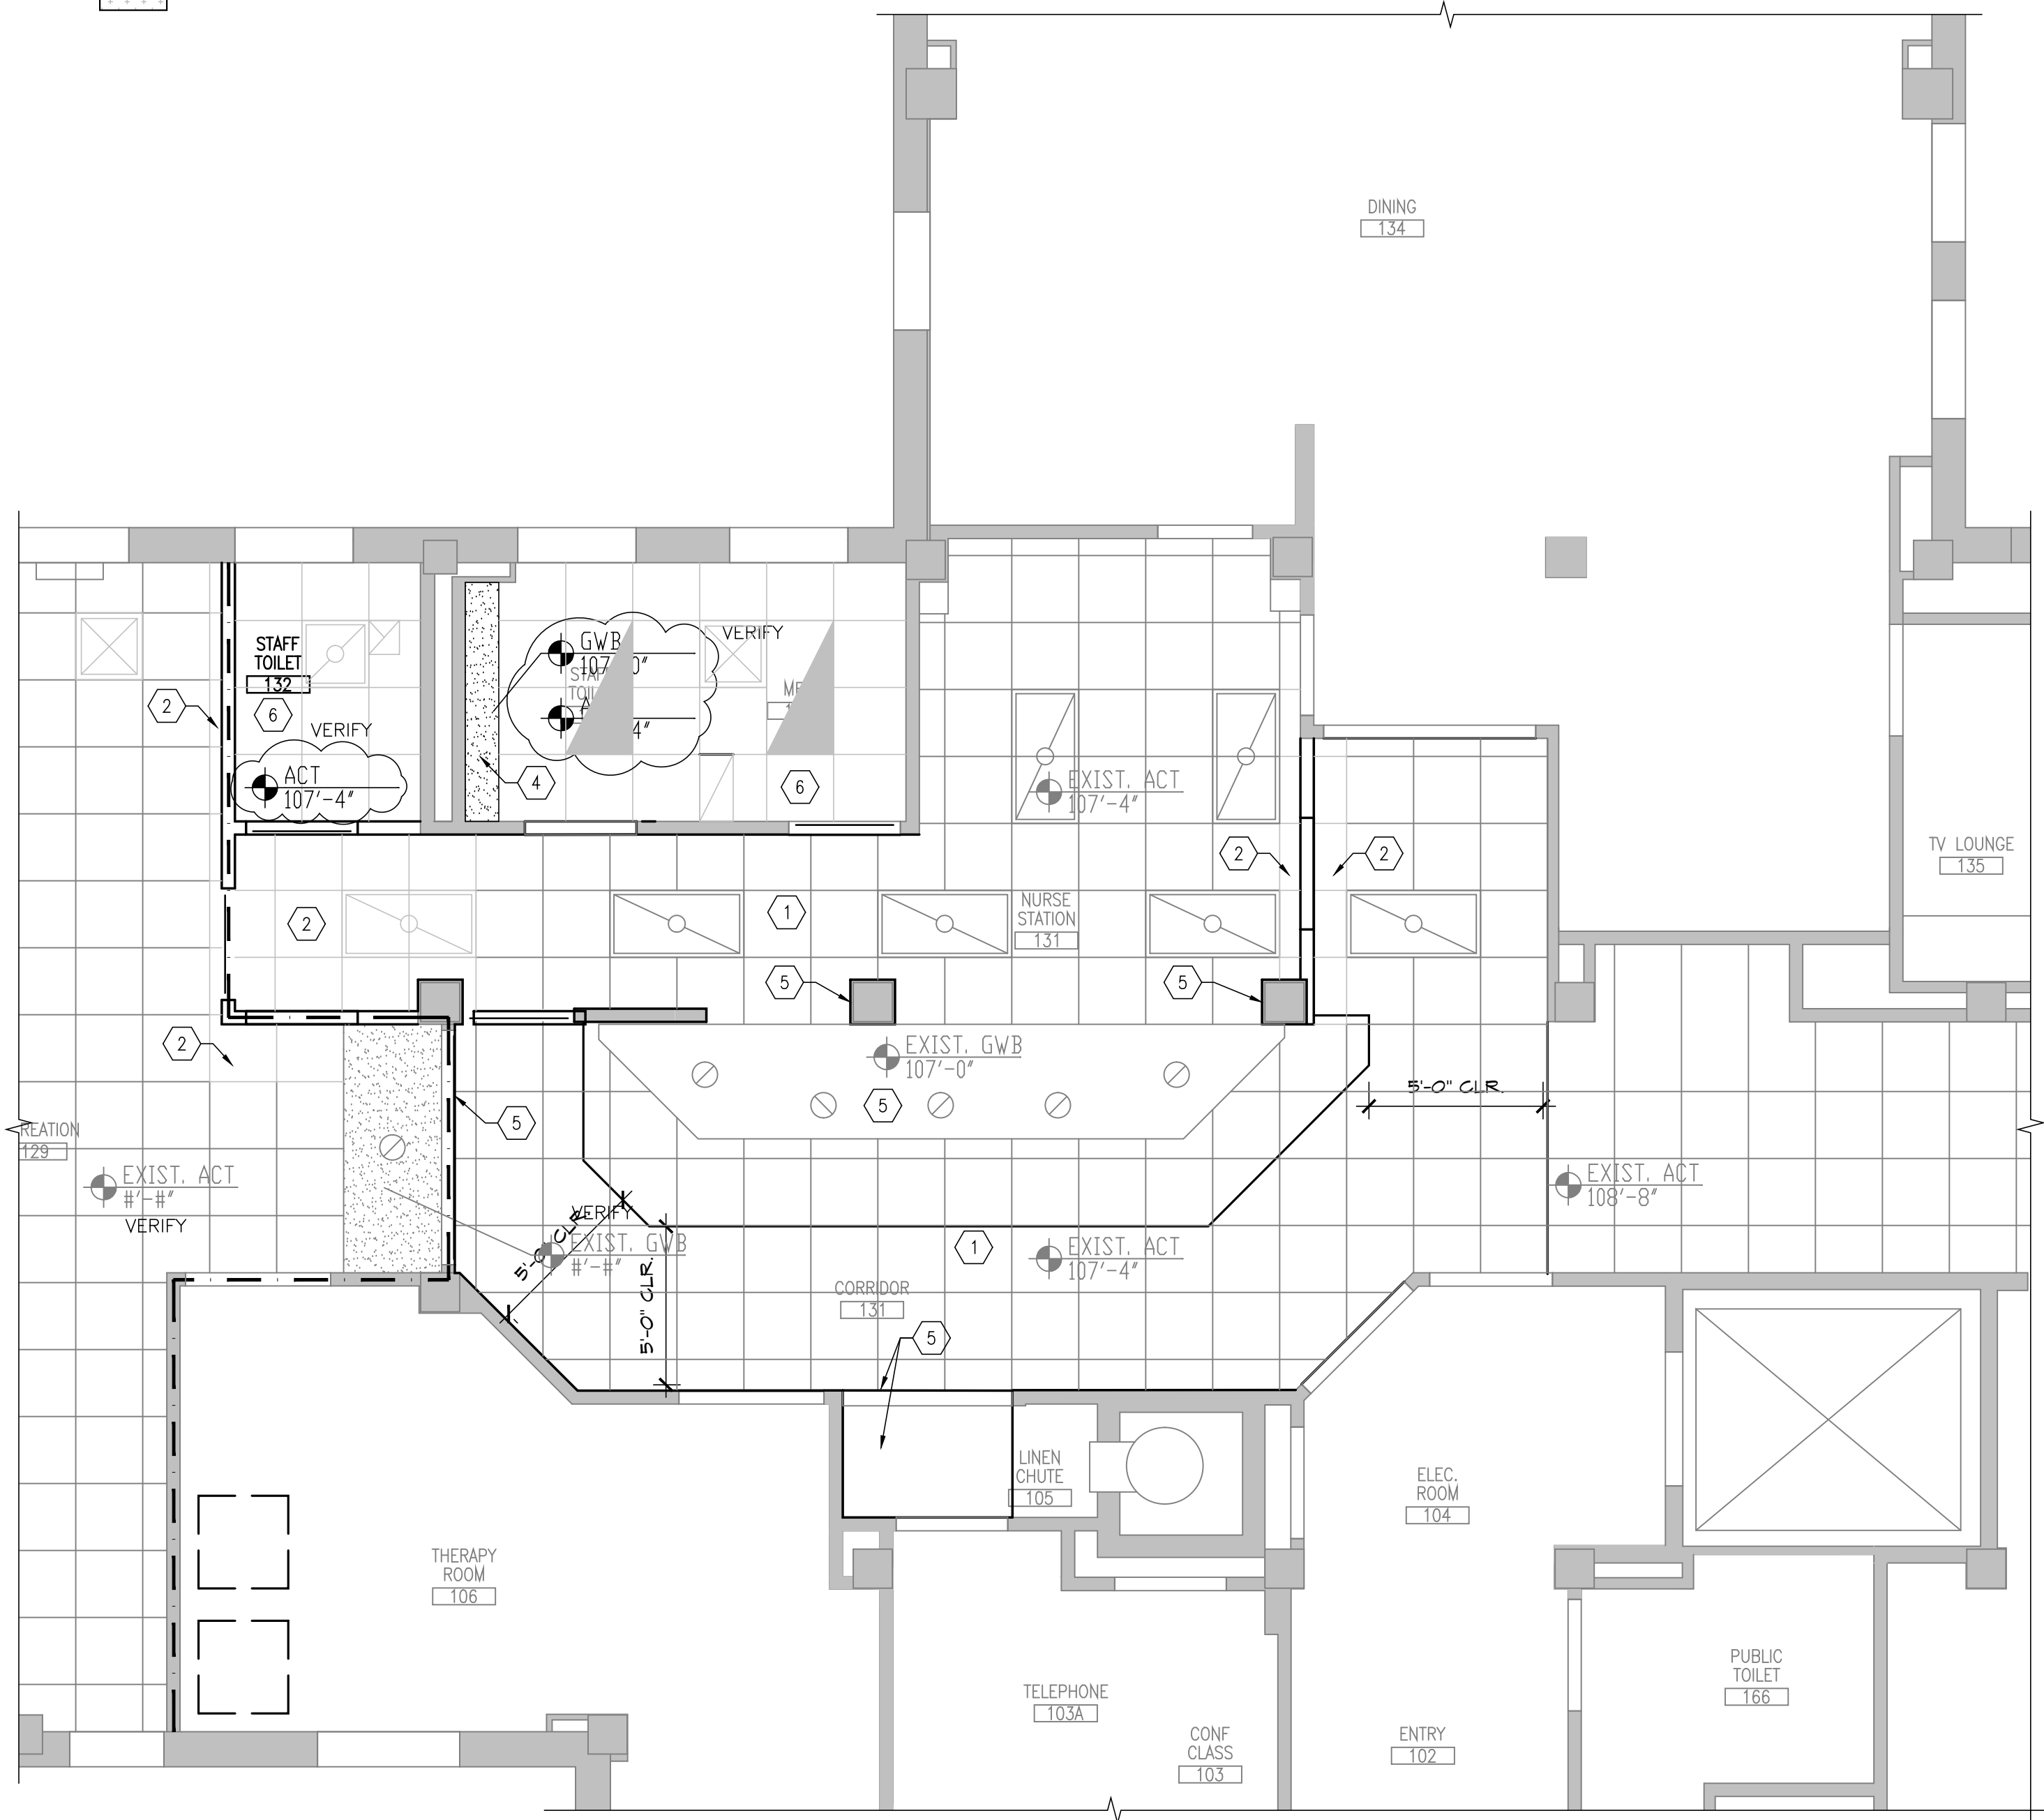
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- 2X4 LAY-IN FLUORESCENT LIGHT FIXTURE
- 2X4 LAY-IN EMERGENCY POWER FLUORESCENT LIGHT FIXTURE
- EXIT SIGN W/ DIRECTIONAL MARKERS
- CEILING HEIGHT MARKER
- SUPPLY AIR
- RETURN AIR
- EXHAUST AIR
- RECESSED CAN LIGHTING
- SPRINKLER LOCATION
- SPEAKER LOCATION
- CURTAIN TRACK
- NURSE CALL LIGHT
- BOUNDARY AREA FOR DEDUCT ALTERNATE #2

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- 6 NEW ACT
- 7 EXISTING SOFFIT TO RECEIVE NEW PAINT
- 8 REPLACE DISTURBED A.C.T./GRID AND RELOCATED FIXTURES, DEVICES, AND SPRINKLER HEADS THAT WERE TEMPORARILY MOVED DUE TO



1 BLDG 51: FIRST FLOOR DEMO REFLECTED CEILING PLAN - NURSE STATION 131

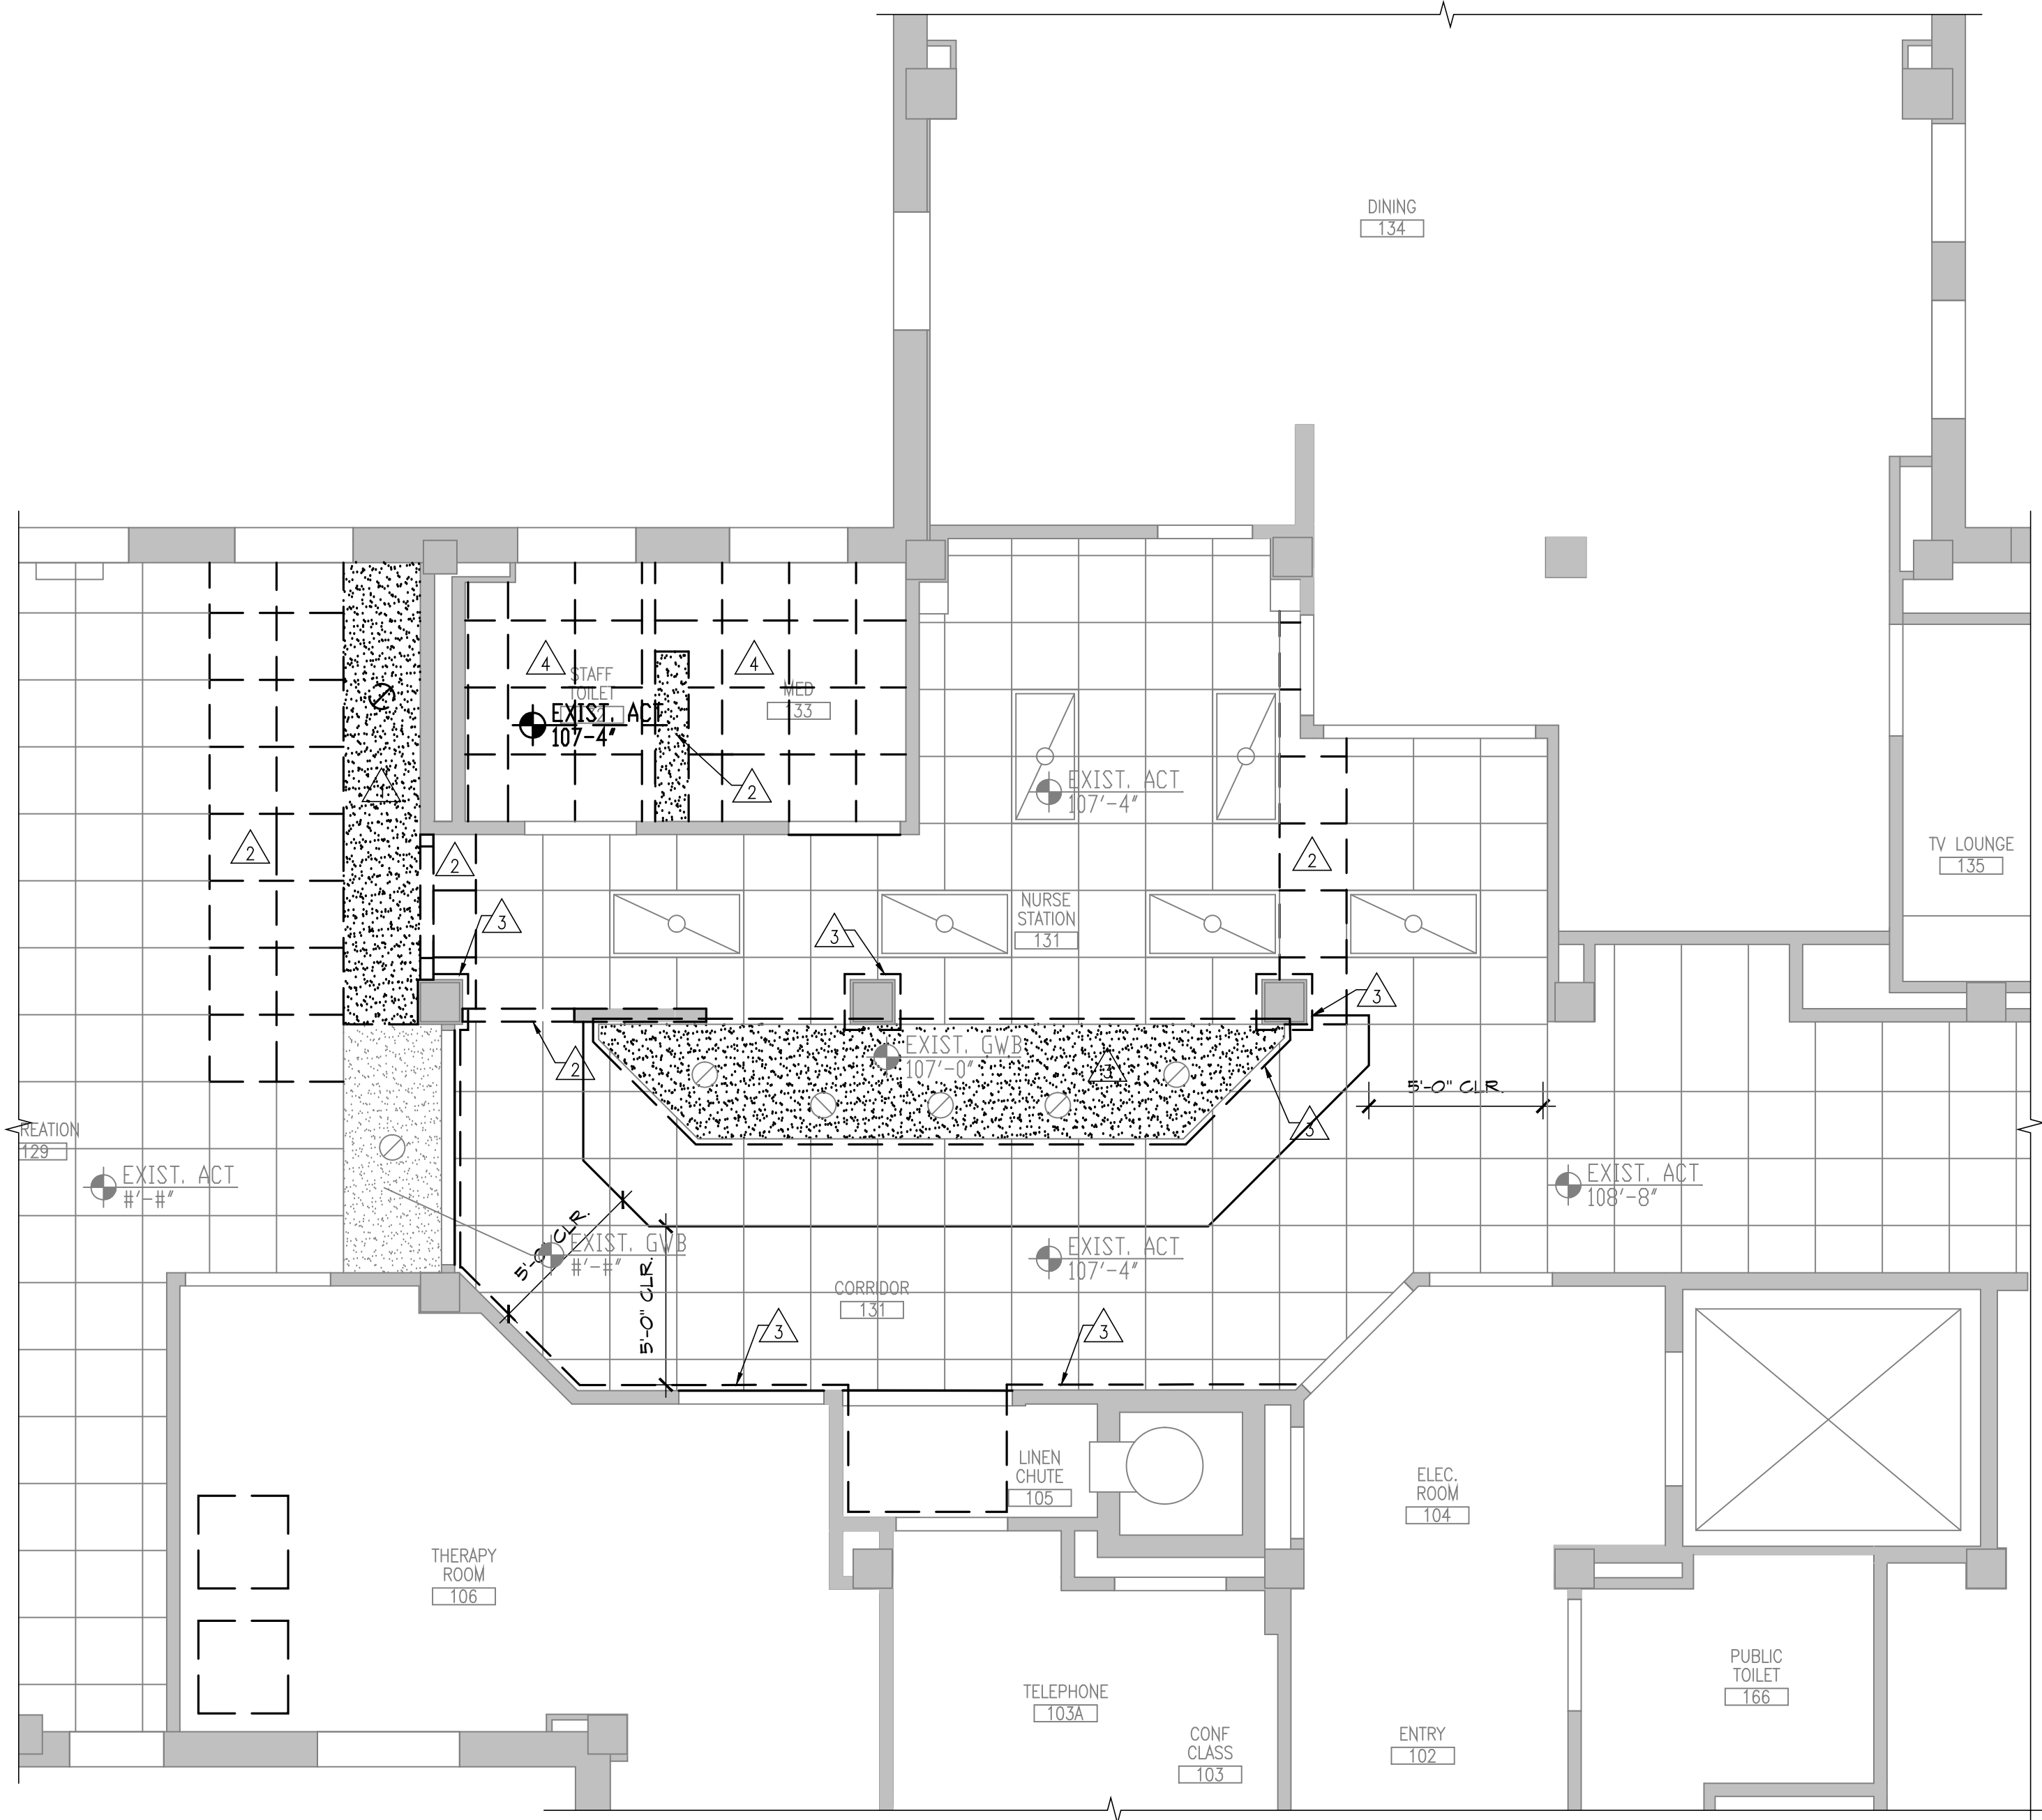

2 BLDG 51: FIRST FLOOR REFLECTED CEILING PLAN - NURSE STATION 131

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DANIEL J. MILLER, AIA
DATE: 09.15.2013
RES. NO.

DRAWING TITLE
**BUILDING 51, FIRST FLOOR
REFLECTED CEILING PLANS**

PROJECT TITLE
UPGRADE RECEPTION STATIONS
BLDG 51 & 51

DATE
5/15/2013

PROJECT NO.
656-13-226

CAN FILE
AS-6-B51-1-RCP.DWG

DRAWING NO.
AST

DATE
8 OF 21

St. Cloud VA
Health Care System
Brainerd | Montevideo | Alexandria

GENERAL REFLECTED CEILING PLAN DEMOLITION NOTES:

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GENERAL NOTES:


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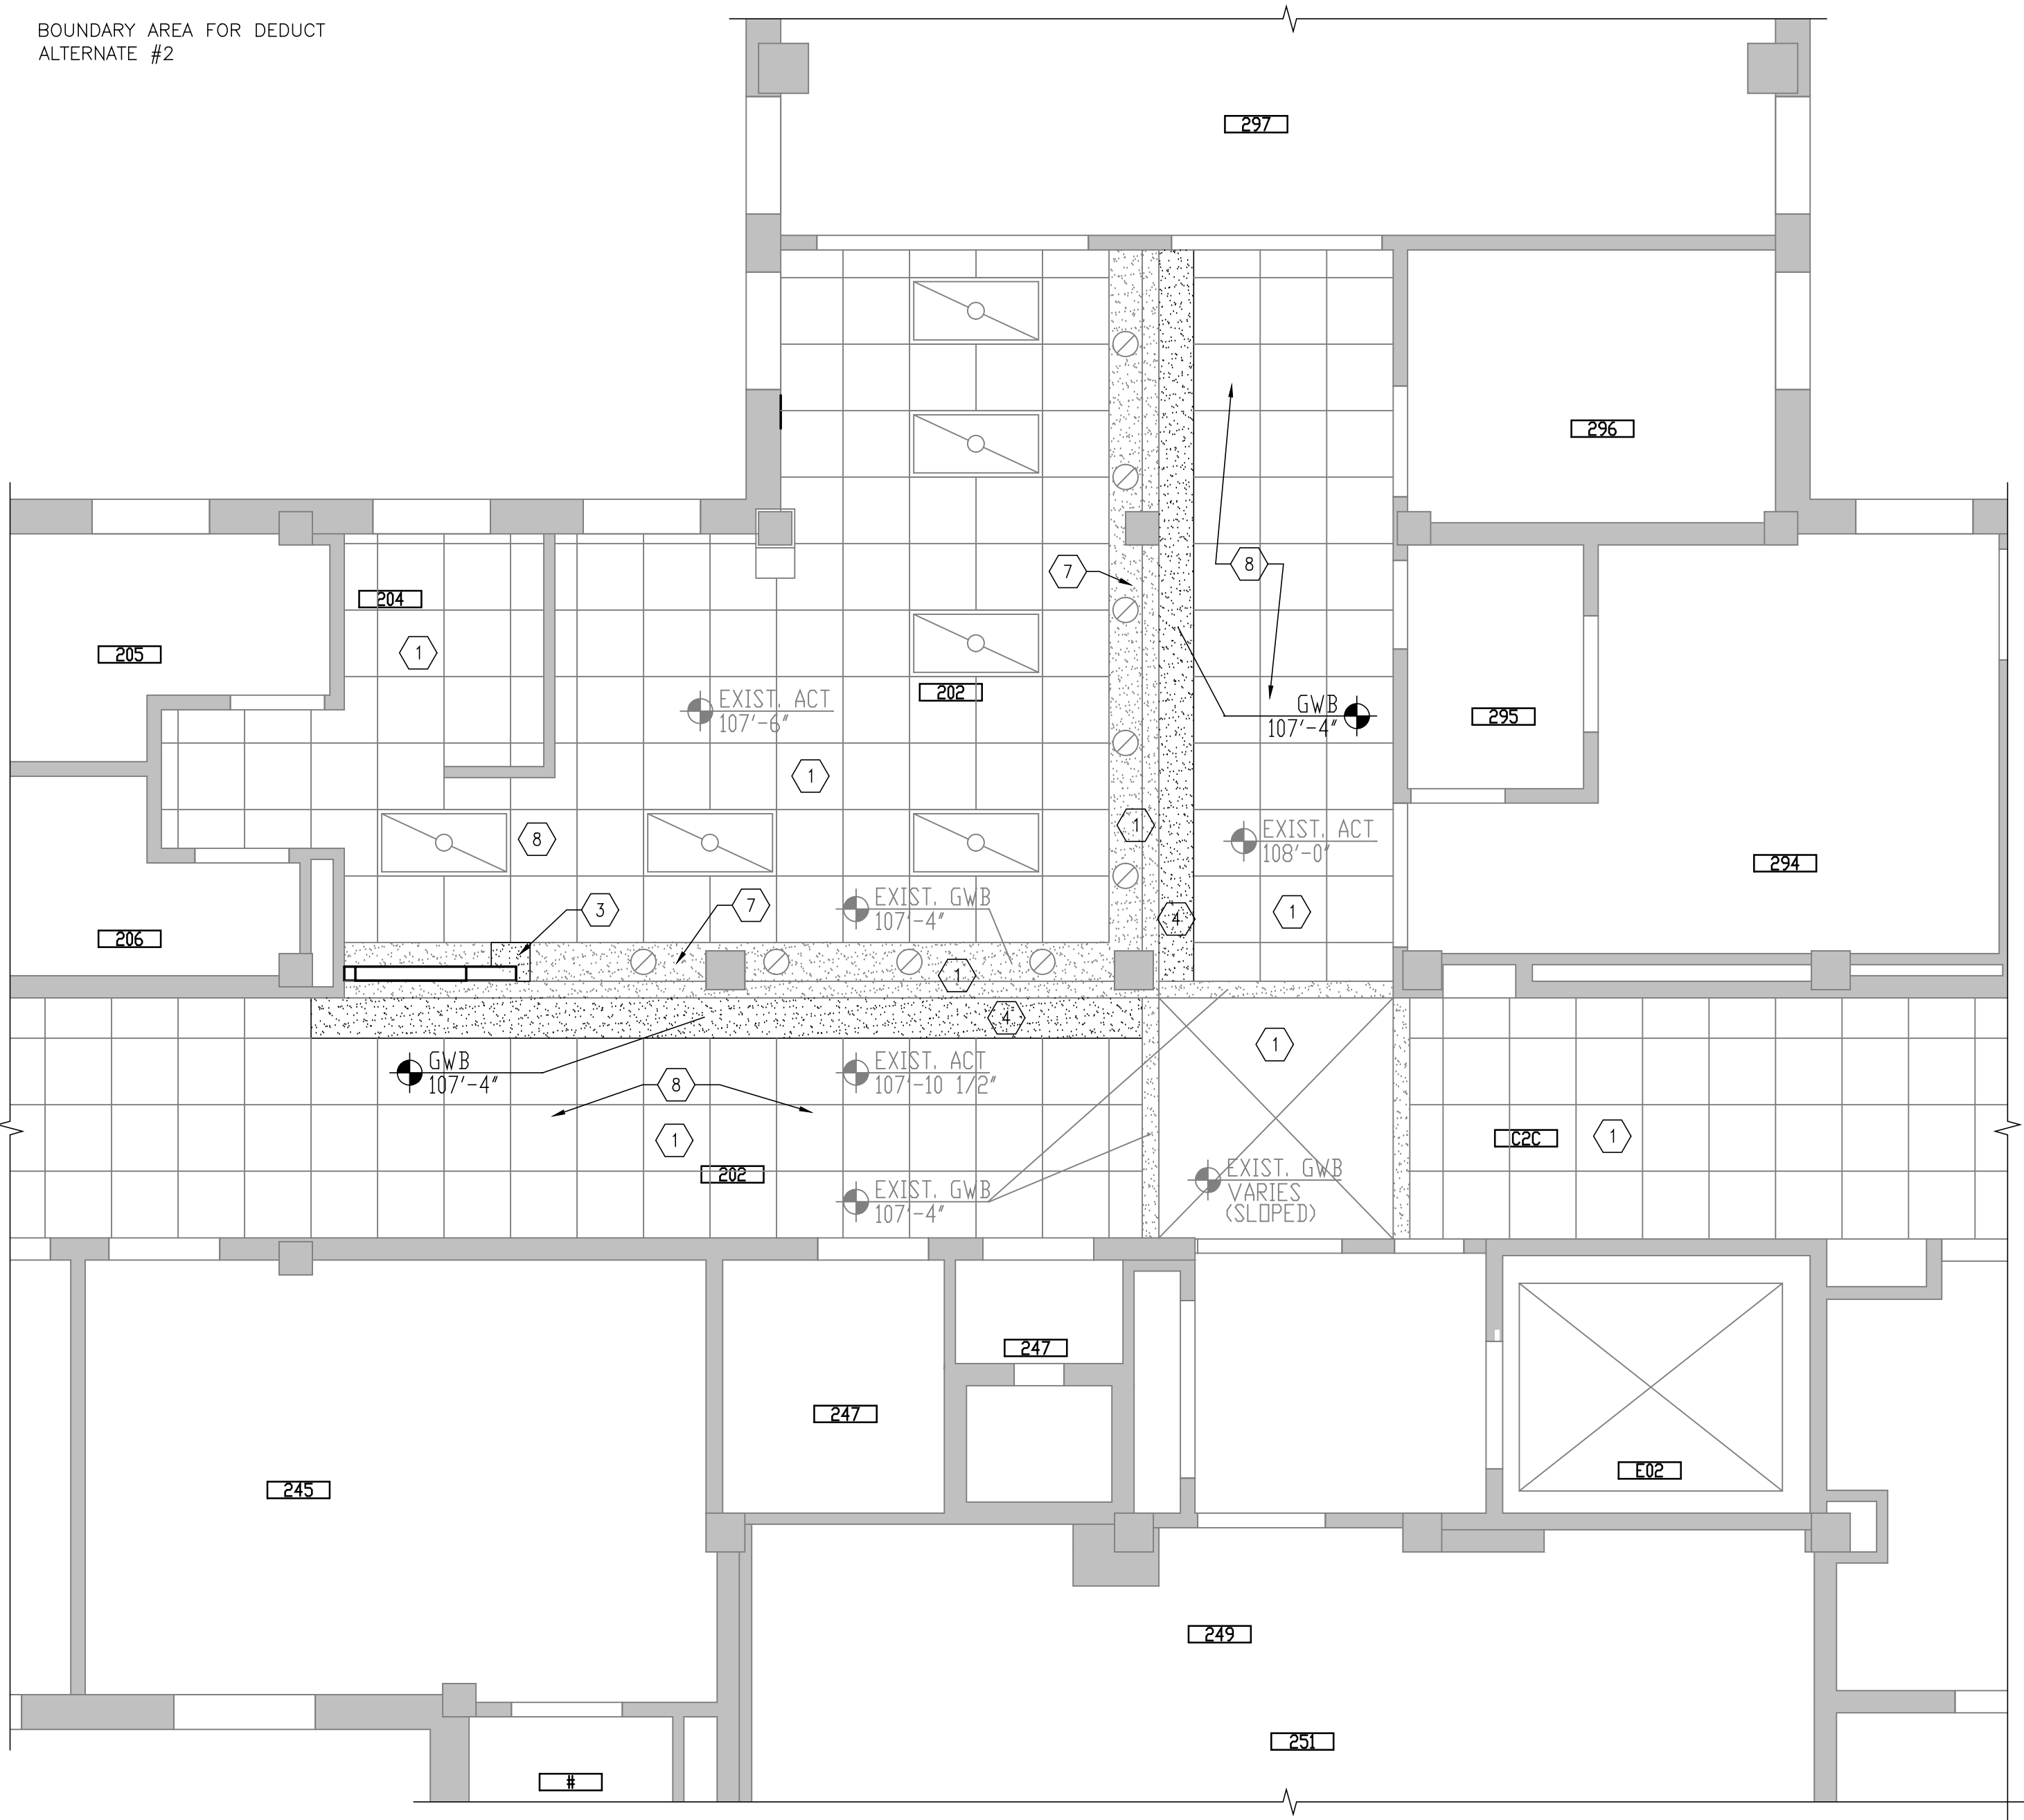
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1 BLDG 51: SECOND FLOOR DEMO REFLECTED CEILING PLAN - NURSE STATION 202
1/4" = 1'-0"



2 BLDG 51: SECOND FLOOR REFLECTED CEILING PLAN - NURSE STATION 202
1/4" = 1'-0"

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DATE: 09.15.2013
RES. NO.

DRAWING TITLE
BUILDING 51, SECOND FLOOR
REFLECTED CEILING PLANS

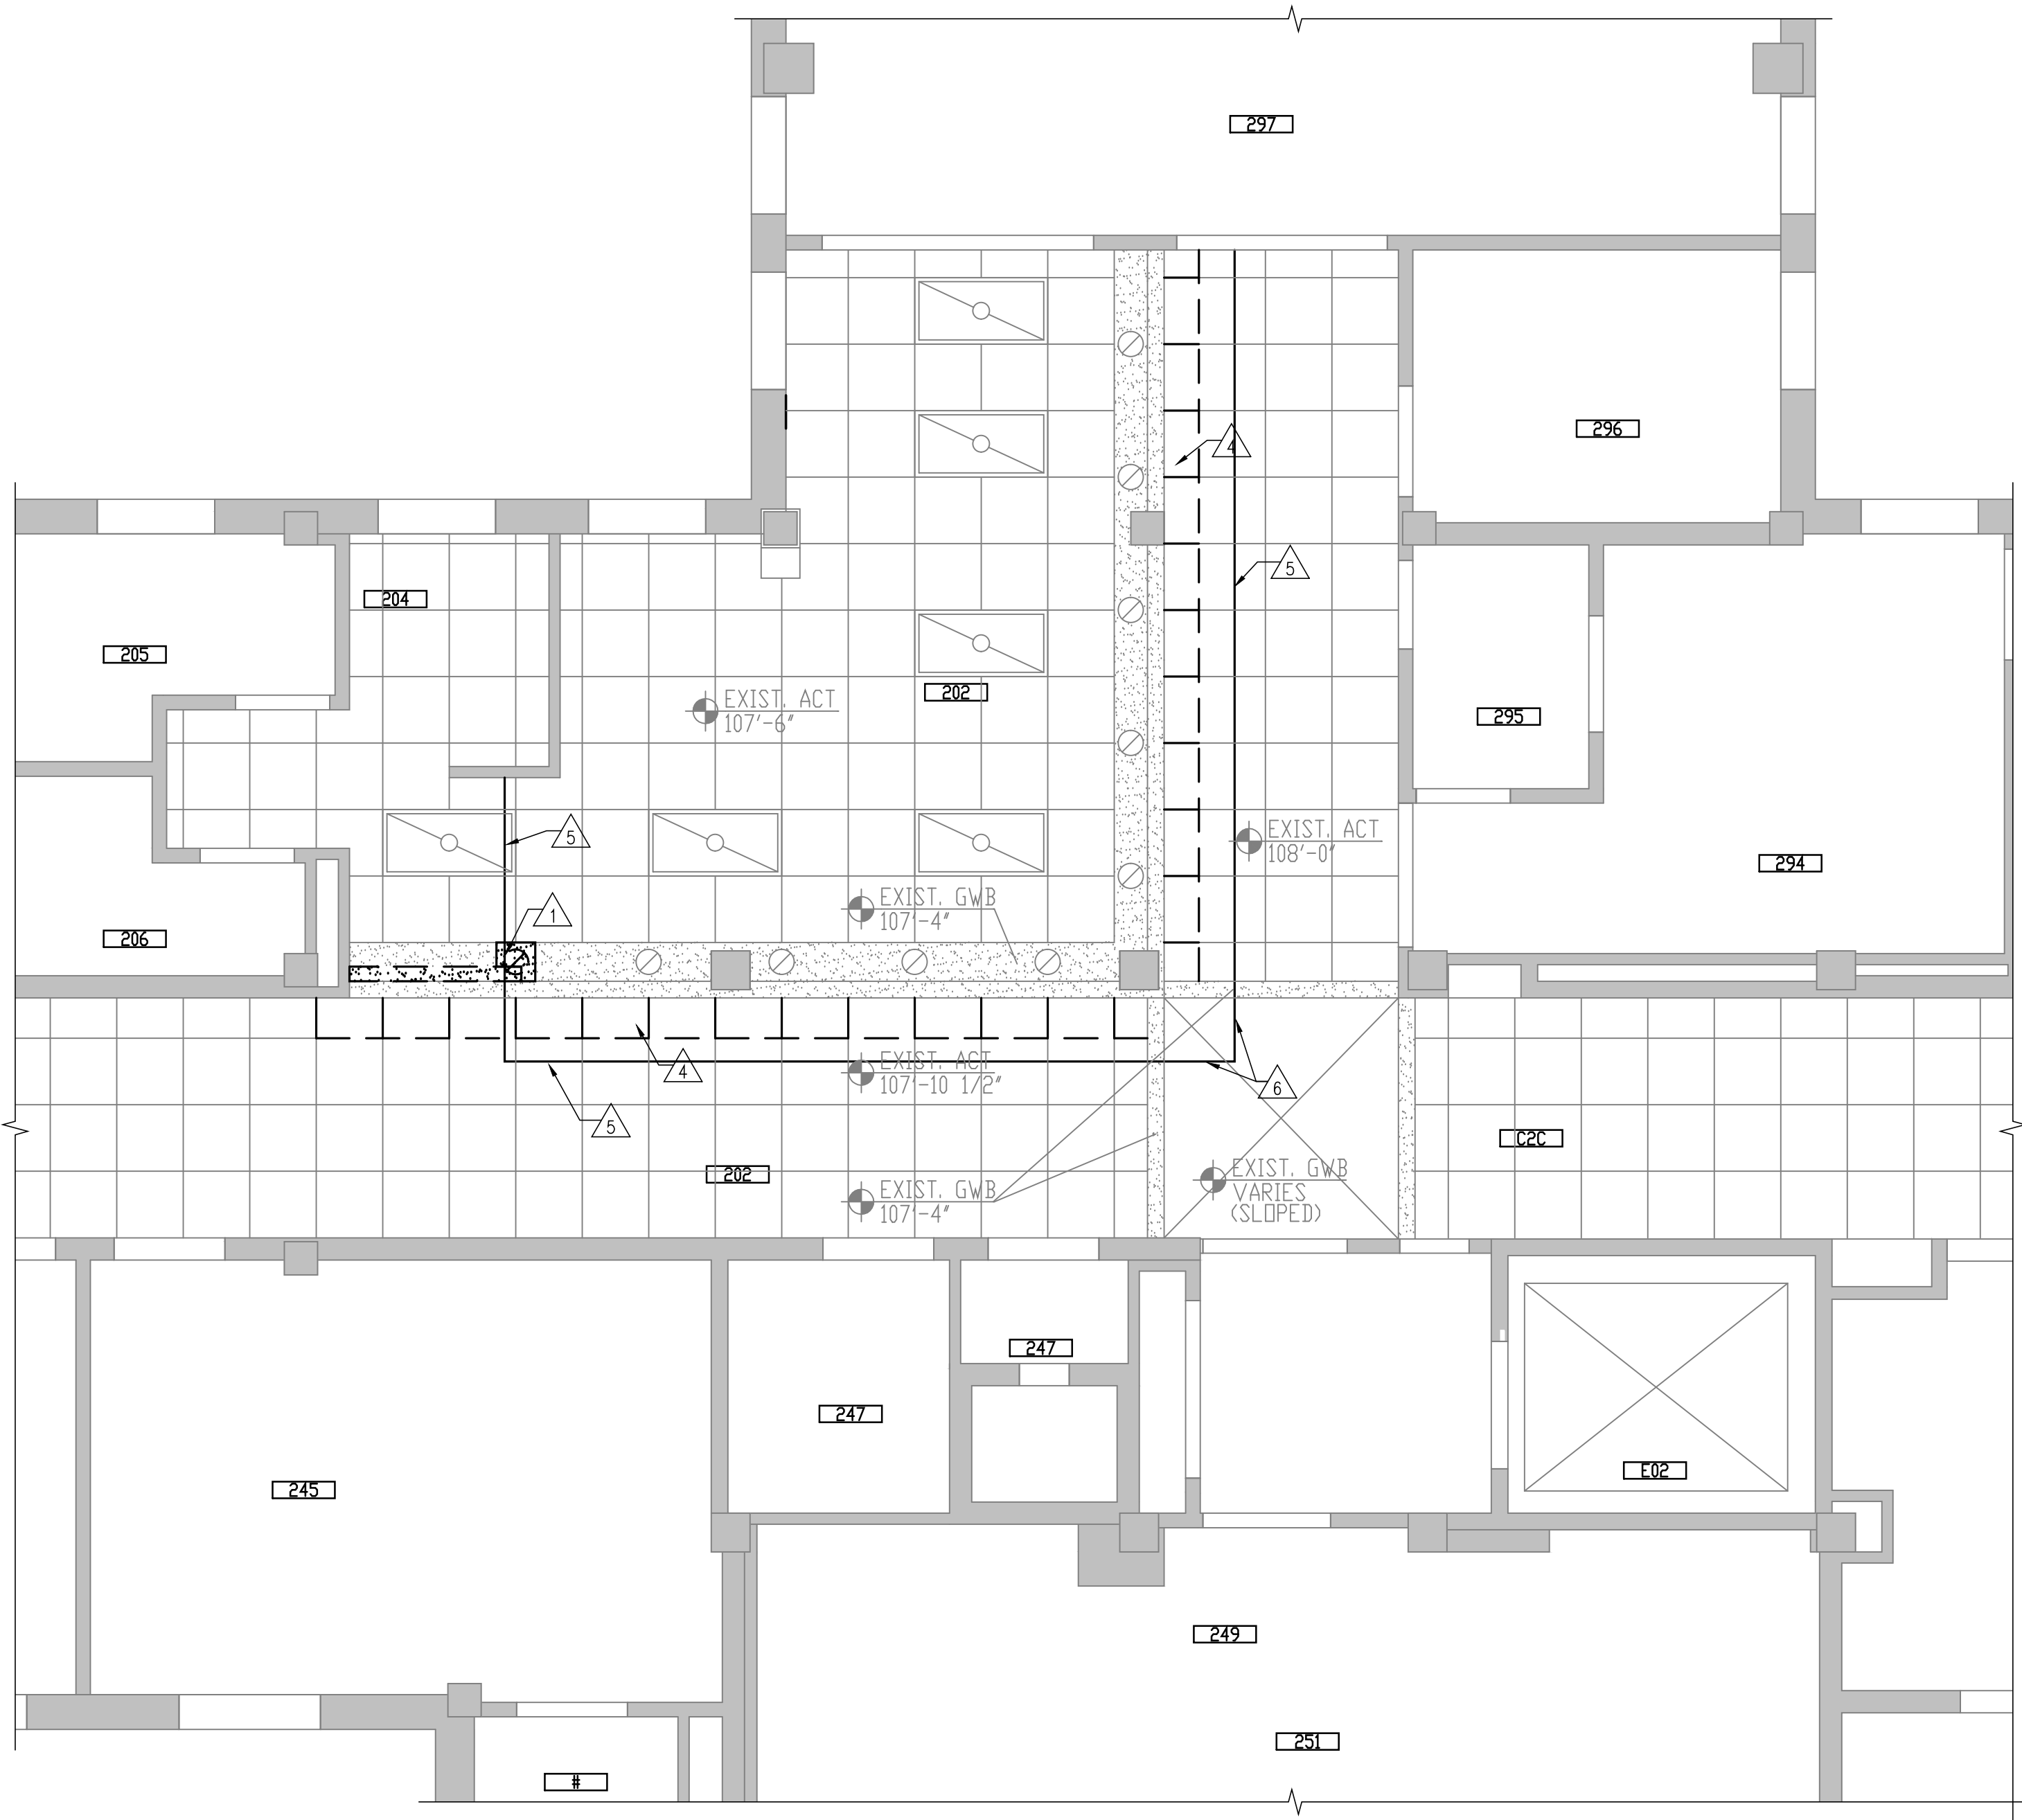PROJECT TITLE
UPGRADE RECEPTION STATIONS
BLDG 2 & 51
DATE
5/15/2013
PROJECT NO.
656-13-226
DRAWING NO.
ASB
9 OF 21

